05510.E1 1 1/2" O.D. HANDRAILING

05521 PIPE & TUBE RAILINGS

05521.A1 1 1/2" O.D. STEEL GUARDRAIL

05521.C1 1/2" O.D. PICKET RAILING @ 4" O.C.

05521.B1 1 1/2" O.D. HANDRAIL

GRATINGS 05530 05530.A0 TRENCH FRAME - GALVANIZED 05530.A1 STEEL GRATE 22-W-4 (SIZE) GALVANIZED 05530.B0 ALUMINUM BAR PANELS WOOD AND PLASTICS DIVISION 6 MISCELLANEOUS CARPENTRY 06105.L2 BLOCKING AS REQUIRED 06105.P1 2X4 06105.P2 2X6 06105.P6 4X4 06105.P9 2 x FRAMING, FIRE TREATED 06105.P10 PRESSURE TREATED WOOD TIMBER (SIZE) 06105.Q2 SHIM AS REQUIRED 06105.R2 SHEATHING - PLYWOOD (THICKNESS) GRADE (SIZE) 06105.R3 G1S A/C PLYWOOD (THICKNESS) 06105.V1 EXTERIOR GRADE PLYWOOD (THICKNESS) 06105.V6 PEGBOARD (THICKNESS) 06105.Z0 ANCHOR AS REQUIRED INTERIOR ARCHITECTURAL WOODWORK 06402.A0 SILL 06402.A1 3/4" PAINTED WOOD SILL 1 06402.B1 PLASTIC LAMINATE BACKSPLASH (HEIGHT) 06402.C1 PAINT GRADE WOOD CAP (THICK.) 06402.HO SHELF(VES) 06402.H1 ADJUSTABALE SHELVES 06402.H2 SHELVING (DEPTH) 06402.K0 BASE UNIT (FINISH) 06402.K2 BASE UNIT W/ADJ. SHELF(VES) (FINISH) 06402.K3 BASE UNIT W/DRAWERS (FINISH) 06402.K4 BASE UNIT W/DRAWER & ADJ. SHELF(VES) (FINISH) 06402.L2 WALL UNIT W/ADJ. SHELF(VES) (FINISH) 06402.P0 COUNTERTOP 06402.P2 COUNTERTOP - P. LAM. ON 3/4" PLYWOOD 06402.X0 WORKBENCH DIVISION THERMAL AND MOISTURE PROTECTION 07160 BITUMINOUS DAMPROOFING 07160.A0 BITUMINOUS DAMPROOFING 07190 WATER REPELLANTS 07190.AO CLEAR WATER RESISTANT COATING 07210 BUILDING INSULATION 07210.A1 BATT INSULATION (R-VALUE) 07210.B1 RIGID INSULATION (THICKNESS) 07210.D0 VAPOR BARRIER 07210.E0 FOUNDATION WALL INSULATION (THICKNESS) 07901 JOINT SEALANTS 07901.A0 SEALANT 07901.B0 ASPHALT SATURATED FIBERBOARD 07901.C0 CAULK 07901.D0 JOINT FILLER 07901.GO BACKER ROD DIVISION 8 DOORS AND WINDOWS 08111 STANDARD STEEL DOORS AND FRAMES 08111.AO PRESSED METAL FRAME 08111.A1 GROUT-FILLED PRESSED METAL FRAME 08111.B0 HOLLOW METAL DOOR 08111.C0 JAMB ANCHOR SECTIONAL OVERHEAD DOORS 08360.A0 OVERHEAD SECTIONAL DOOR 08360.B0 DOOR TRACK 08360.C0 WEATHERSTRIPPING 08360.D0 DOOR GUIDE 08520 ALUMINUM WINDOWS 08520.A0 WINDOW UNIT 08520.B0 FIXED WINDOW 08520.CO ALUM. WINDOW W/SLIDING GLASS PANEL 08520.MO SILL STARTER, SET IN SEALANT 08520.P0 BREAKMETAL 08520.Q0 WEATHERSTRIPPING 08520.RO ALUMINUM FLASHING, FINISH TO MATCH WINDOW FRAME

DOOR HARDWARE 08710 08710.A0 THRESHOLD 08710.CO WEATHERSTRIPPING 08800 GLAZING 08800.C0 WIRE GLASS 08800.G1 CLEAR INSULATING GLASS (SIZE) 08800.G3 OPAGUE INSULATING GLASS FINISHES DIVISION GYPSUM BOARD ASSEMBLIES 09255.A1 GYPSUM BOARD (THICKNESS) 09255.A2 WATER RESISTANT GYPSUM BOARD (THICKNESS) 09255.B2 TYPE 'X' GYPSUM BOARD (THICKNESS) 09255.C3 CEMENT BOARD (THICKNESS) 09255.H0 METAL STUD 09255.H1 METAL STUDS (SIZE, SPACING) 09255.J0 METAL RUNNER 09255.K0 DOUBLE STUDS 09255.K1 DOUBLE STUDS (GAGE) 09255.L1 7/8" X 1-3/8" METAL ANGLE 09255.L2 2-1/2" X 2-1/2" METAL ANGLE 09255.M2 METAL CORNER BEAD (TYP) 09255.P0 Z-FURRING CHANNEL 09255.Q0 7/8" METAL FURRING CHANNEL 09255.R2 CHANNEL (SIZE, SPACING) 09255.S1 8 GA. WIRE HANGERS (SPACING) 09255.S2 18 GA. WIRE TIES 09255.S3 18 GA. METAL MOUNTING STRIPS 09255.S4 14 GA. STAINLESS STEEL COUNTER TOP 09255.U1 SUSPENDED CEILING SYSTEM 09255.V0 EDGE TRIM (TYP) 09255.V2 LC-BEAD (PREFERRED USG 200-A TRIM) 09255.V4 VINYL TRIM 09300 TILE 09300.A1 TILE UNGLAZED CERAMIC MOSAIC-TILE TYPE#1 09300.A2 TILE GLAZED WALL-TILE TYPE#2 09300.CO TILE BASE 09300.D1 BULLNOSE TRIM UNIT 09300.G1 MORTAR BED 09300.G4 WATERPROOF MEMBRANE 09660 RESILIENT TILE FLOORING 09660.A1 VINYL COMPOSITION TILE TYPE #1 09678 RESILIENT WALL BASE AND ACCESSORIES 09678.E1 RUBBER BASE (SIZE) 09900 PAINTING 09900.A1 PAINT - TYPE #1 09900.A2 PAINT - TYPE #2 09900.A3 PAINT - TYPE #3 SPECIALTIES DIVISION 10 10100 VISUAL DISPLAY BOARDS 10100.C0 MARKER BOARD 10100.D0 TACK BOARD 10425 SIGNS 10425.A0 SIGNAGE 10425.A1 OIL SIGNAGE 10425.B1 WELDING SIGNAGE 10425.C1 ACCESSIBLE SIGNAGE 10425.D1 ACCESSIBLE/UNISEX RESTROOM SIGNAGE 10500 METAL LOCKERS AND STORAGE CABINETS 10500.A0 METAL LOCKERS 10500.B0 METAL STORAGE CABINETS 10522 FIRE EXTINGUISHERS, CABINETS, AND ACCESSORIES 10522.A0 FIRE EXTINGUISHER

TOILET AND BATH ACCESSORIES 10800.B0 PAPER TOWEL DISPENSER & WASTE RECEPTACLE 10800.C0 TOILET TISSUE DISPENSER 10800.D0 MOP RACK 10800.E0 GRAB BAR 10800.E1 GRAB BAR (SHOWER) 10800.H0 SOAP DISPENSER 10800.H1 SOAP DISH 10800.P1 SHOWER CURTAIN ROD 10800.P2 SHOWER CURTAIN 10800.R1 FRAMED MIRROR (SIZE) 10800.T1 FOLDING SHOWER SEAT 10800.TO METAL SHELF (SIZE) DIVISION 11 EQUIPMENT 11151 MOBILE LIFT 11151.AO FIXED LIFT 11151.A0 MOBILE LIFT - (ALT. BID) DIVISION 12 FURNISHINGS 12511 HORIZONTAL LOUVER BLINDS 12511.AO HORIZONTAL LOUVER BLINDS DIVISION 13 SPECIAL CONSTRUCTION 13125 METAL ARCH BUILDING SYSTEM 13125.AO METAL ARCH BUILDING SYSTEM 13125.BO STANDING SEAM METAL ROOF 13125.B1 STANDING SEAM METAL ROOF RIDGE 13125.B2 STANDING SEAM METAL CANOPY 13125.CO METAL RAIN GUTTER W/DOWNSPOUTS 13125.C1 METAL RAIN GUTTER 13125.C2 DOWNSPOUT 13125.C3 GUTTER STRAP, INSTALL AT EVERY OTHER PANEL RIB 13125.DO METAL FLASHING 13125.D1 METAL DRIP FLASHING 13125.D2 METAL HEAD FLASHING 13125.D3 METAL SILL FLASHING 13125.D4 METAL FLASHING, FINISH TO MATCH ROOF PANELS 13125.D5 RIDGE FLASHING, TO MATCH ROOF PANELS 13125.D6 DOOR HEAD FLASHING 13125.D7 JAMB FLASHING 13125.E0 METAL TRIM 13125.E1 JAMB TRIM 13125.E2 PANEL TRIM 13125.E3 RAKE TRIM 13125.E4 RAKE SLIDE 13125.E5 METAL EAVE CLOSURE 13125.E6 WALL CLOSURE 13125.E7 METAL OUTSIDE CLOSURE 13125.E8 CORNER TRIM 13125.E9 FRAMED OPENING HEADER 13125.FO METAL WALL PANEL 13125.F1 METAL WALL FASTENER 13125.F2 BLIND RIVET 13125.F3 POP RIVET 13125.GO METAL FACIA 13125.HO BREAK METAL 13125.H1 METAL ANGLE 13125.H2 HIGH RAKE SUPPORT ANGLE 13125.H3 RAKE ANGLE 13125.H4 4" x 4" CONT. ANGLE 13125.H5 BACKUP PLATE ANGLE 13125.H6 EAVE SUPPORT ANGLE 13125.H7 EAVE STRUT 13125.JO STRUCTURAL MEMBER 13125.J1 STRUCTURAL GIRT 13125.J2 PURLIN 13125.K0 CLIP 13125 K1 LOW PANEL CLIP 13125 L1 STEEL COLUMN - PAINTED 13125.L2 STEEL COLUMN - GALV. - PAINTED 13125.MT STEEL BEAM - GALV. - PAINTED 13125.N1 ANCHOR 13125.N2 FASTENER (SPACING) 13125.P1 DOUBLE BEAD TAPE SEALER 13125.P2 SEALANT 13125.P3 THERMAL BREAK 13125.Q0 METAL VENT 13125.Q1 VENT MATERIAL

DIVISION 14 CONVEYING SYSTEMS

15050.A1 MECH. PENETRATIONS 15251.A1 PIPE INSULATION AT ALL EXPOSED PIPE 15410.A0 URINAL 15410.A1 URINAL, ACCESSIBLE 15410.E1 DRAIN W/ SEDIMENT BUCKET

15412.AO EMERGENCY SHWR & EYE WASH 15452.A1 DRINKING FOUNTAIN 15460.A1 GAS FIRED WATER HEATER 15490.A0 WASTE OIL PUMP 15490.B0 WASTE OIL CARTS 15490.C0 WASTE OIL PIT 15491.AO AIR COMPRESSOR

15611.A1 GAS FIRED FURNACE 15838.AO EXHAUST FAN

16510 INTERIOR LUMINAIRES 16510.A0 INTERIOR LIGHTS 16510.BO INTERIOR WALL LIGHTS

16520.A1 EXTERIOR LIGHTS IN CANOPY 16520.A2 EXTERIOR WALL MOUNTED LIGHTS

CLIENT

DESIGNER

CONSULTANTS

**MEADOW** 

MAINTENANCE FACILITY STATION #4534

400 N. MAIN

MEADOW, UTAH 84644

A DCLUDI EV

architecture • planning • design services

1135 South West Temple, Ste. A

Salt Lake City, UT 84101

P:(801) 961-7070

F:(801) 961-7373

14620 TROLLEY HOIST

14620.A0 TROLLEY HOIST (SIZE) - RE: STRUCTURAL

DIVISION 15 EQUIPMENT

15000 MECHANICAL

15410.B0 SINK FAUCET

15410.B1 SINK FAUCET W/ADA LEVER HANDLES 15410.CO UTILITY SINK

15410.D1 FLOOR SINK 15410.E0 TRENCH DRAIN

15410.E2 FLOOR DRAIN

15491.BO OVERHEAD LUBE REEL 15600.AO NATURAL GAS RADIANT HEATING SYSTEM

15838.A1 ROOF TOP EXHAUST FAN 15887.A1 LOUVER W/ BIRD SCREEN

DIVISION 16 ELECTRICAL

16520 EXTERIOR LUMINAIRES 16520.A0 EXTERIOR LIGHTS

RALPH M. STANISLAW 95-310818-0301

/i\ |09/21/05| ADDENDUM #1 09/02/05 BID DOCUMENTS 08/12/05 FINAL REVIEW SET 07/18/05 PRELIMINARY REVIEW SET

PROJECT NO: 050008.01 DRAWN BY: K. PHILLIPS CHECKED BY: R. STANISLAW SCALE: DATE: SEPTEMBER 2, 2005

SHEET TITLE

MASTER **KEYNOTE LIST** 


G002

© 2004 ARCHIPLEX GROUP


PROFESSIONAL SEAL


MARK DATE DESCRIPTION

KEY PLAN

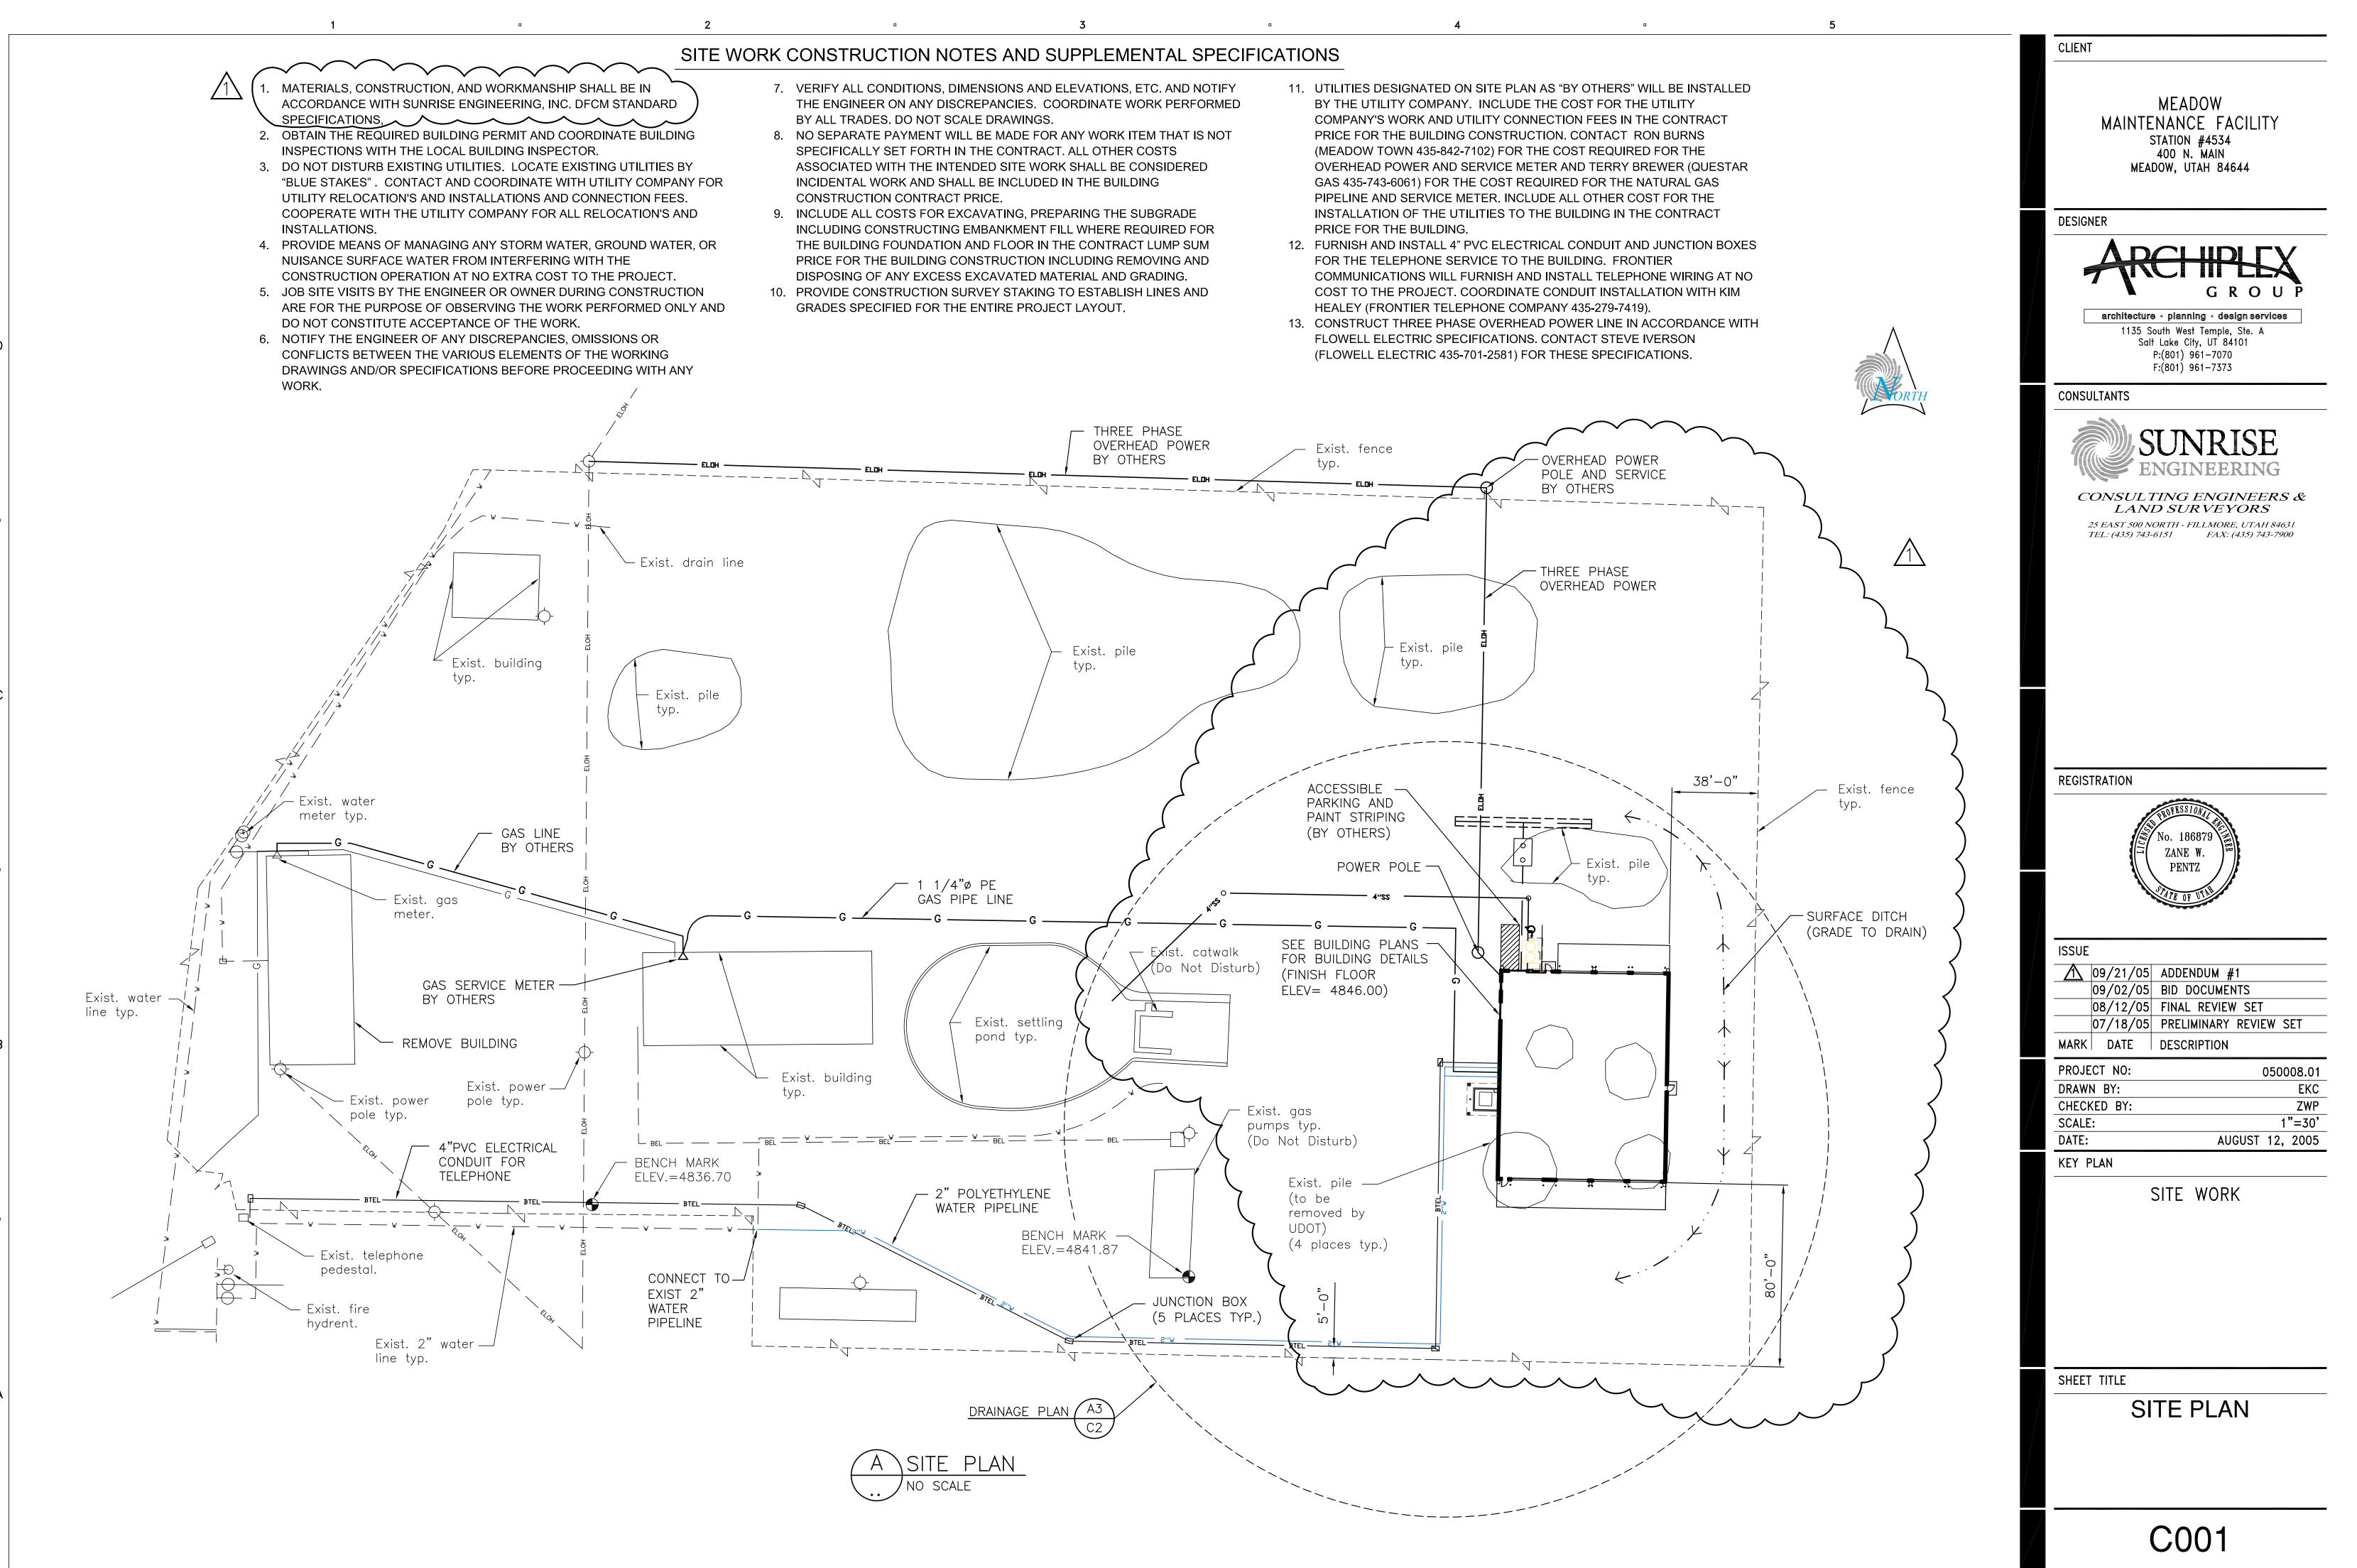


© 2004 ARCHIPLEX GROUP

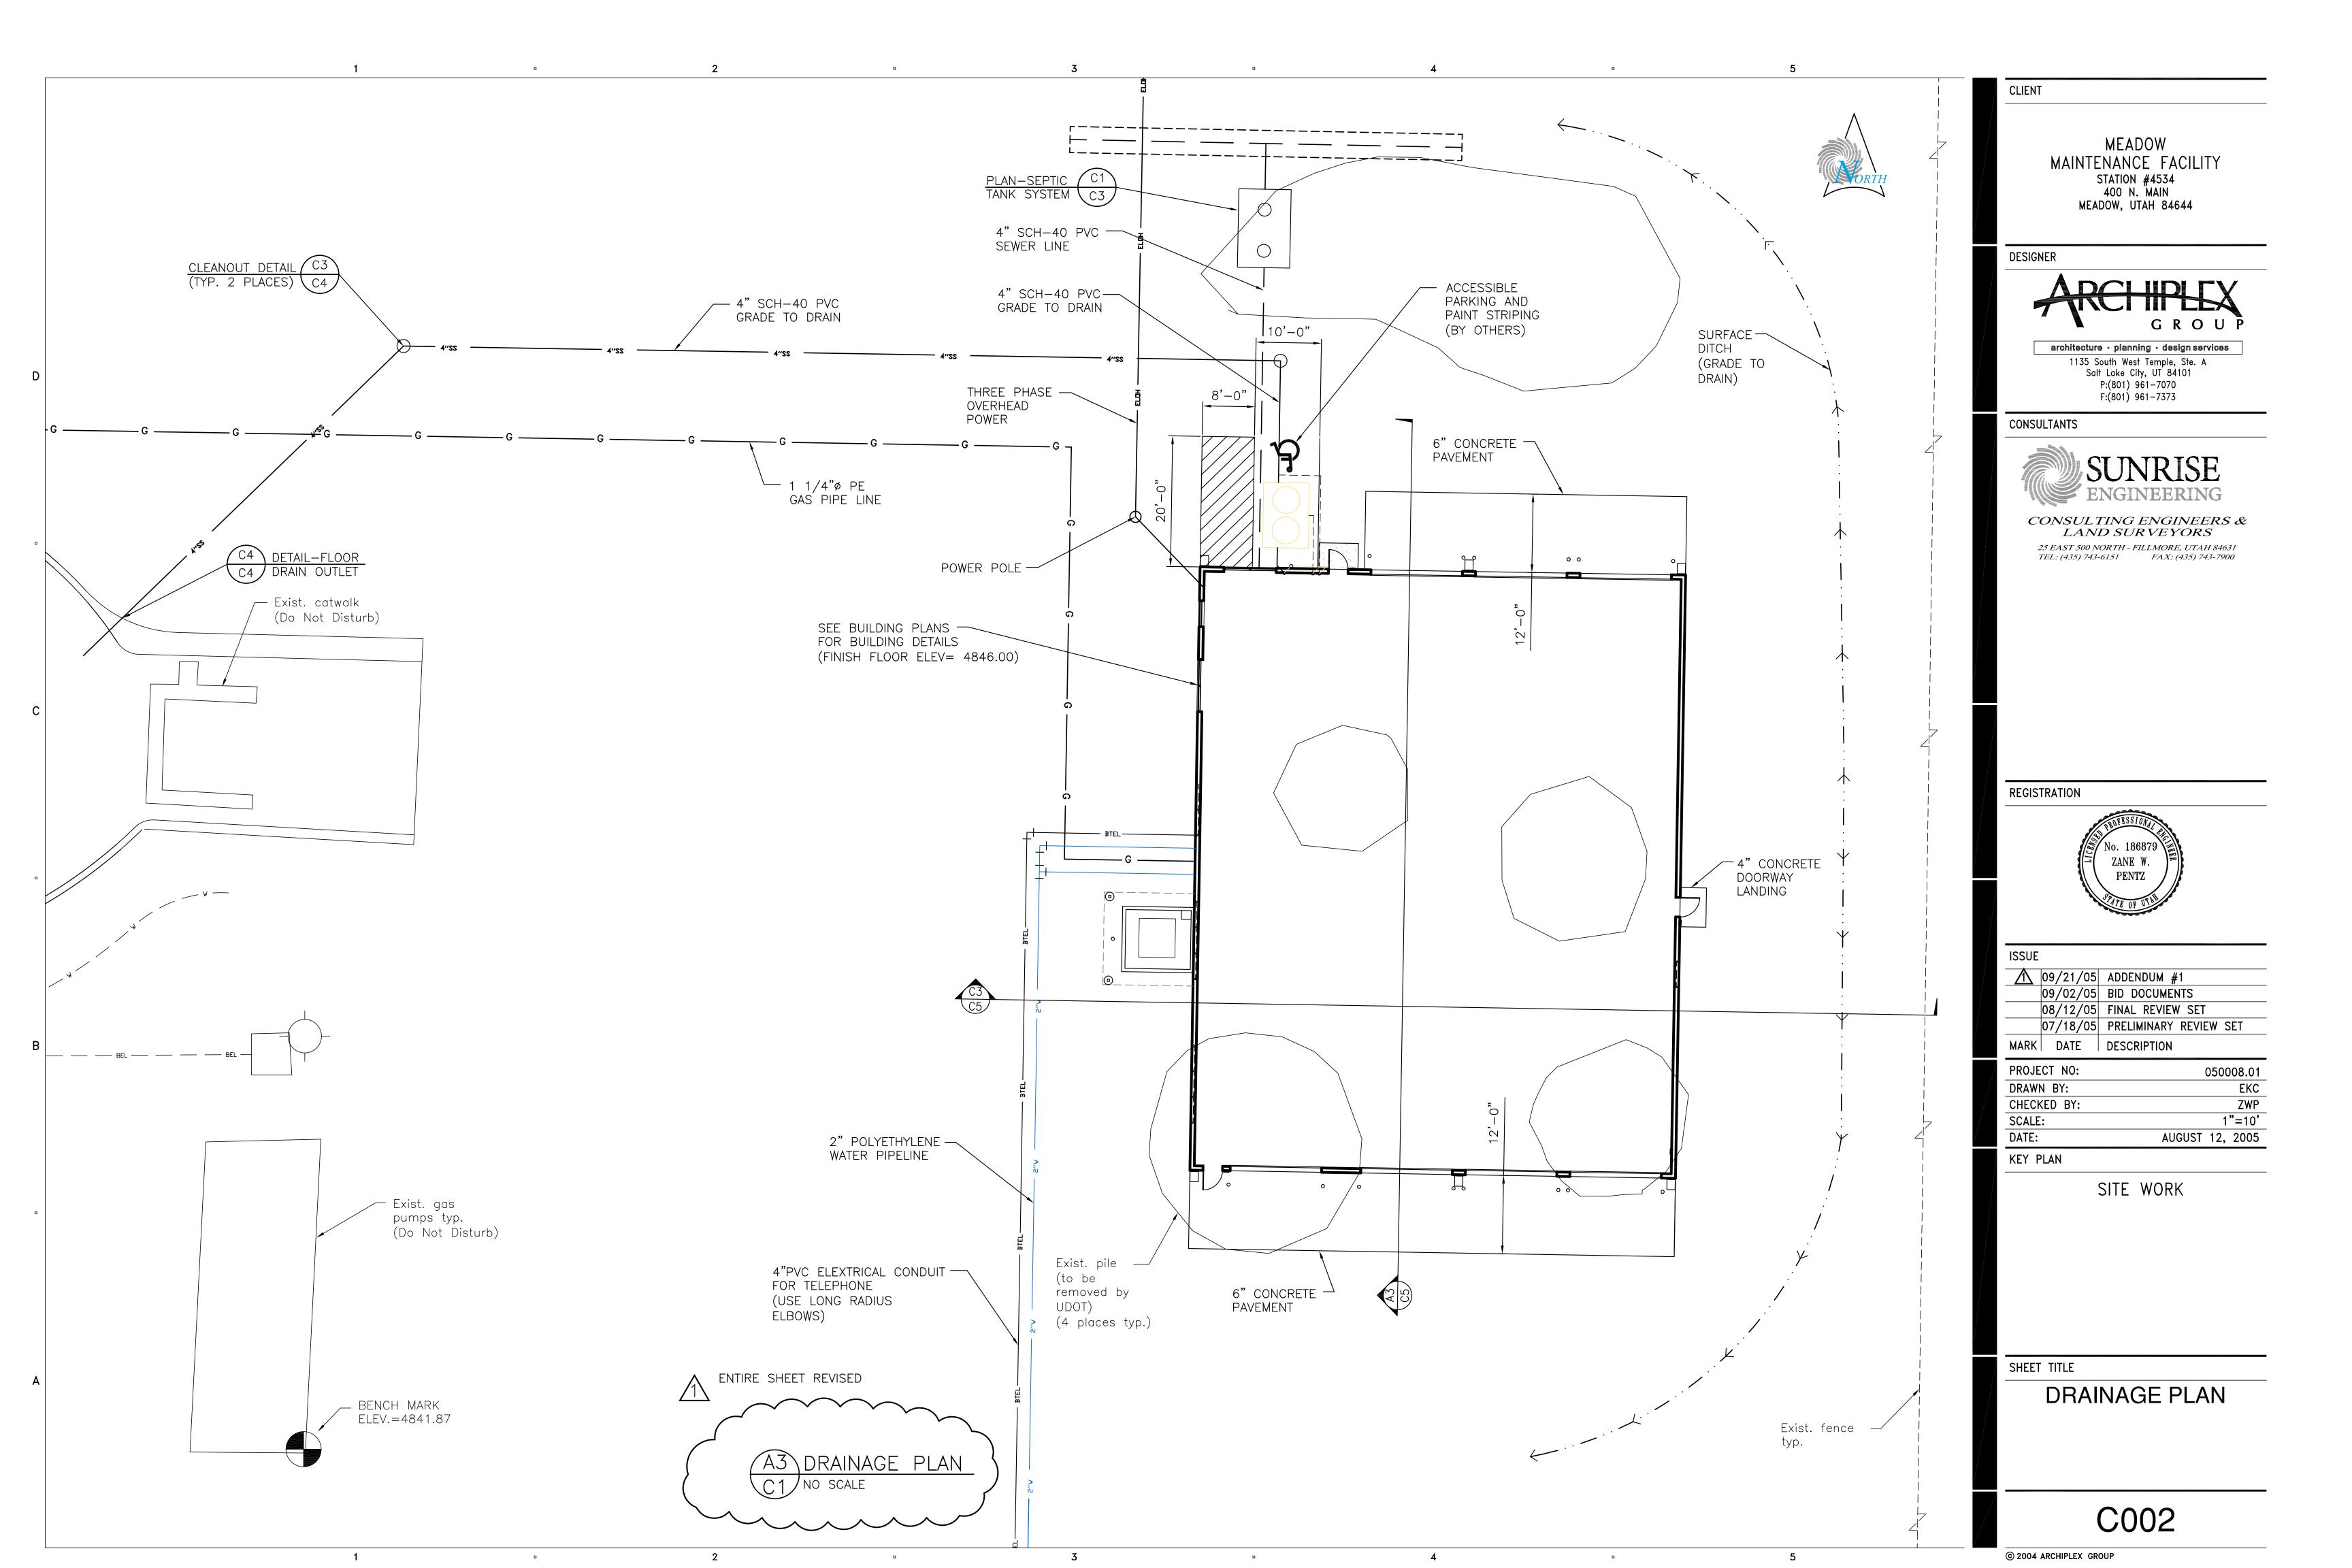

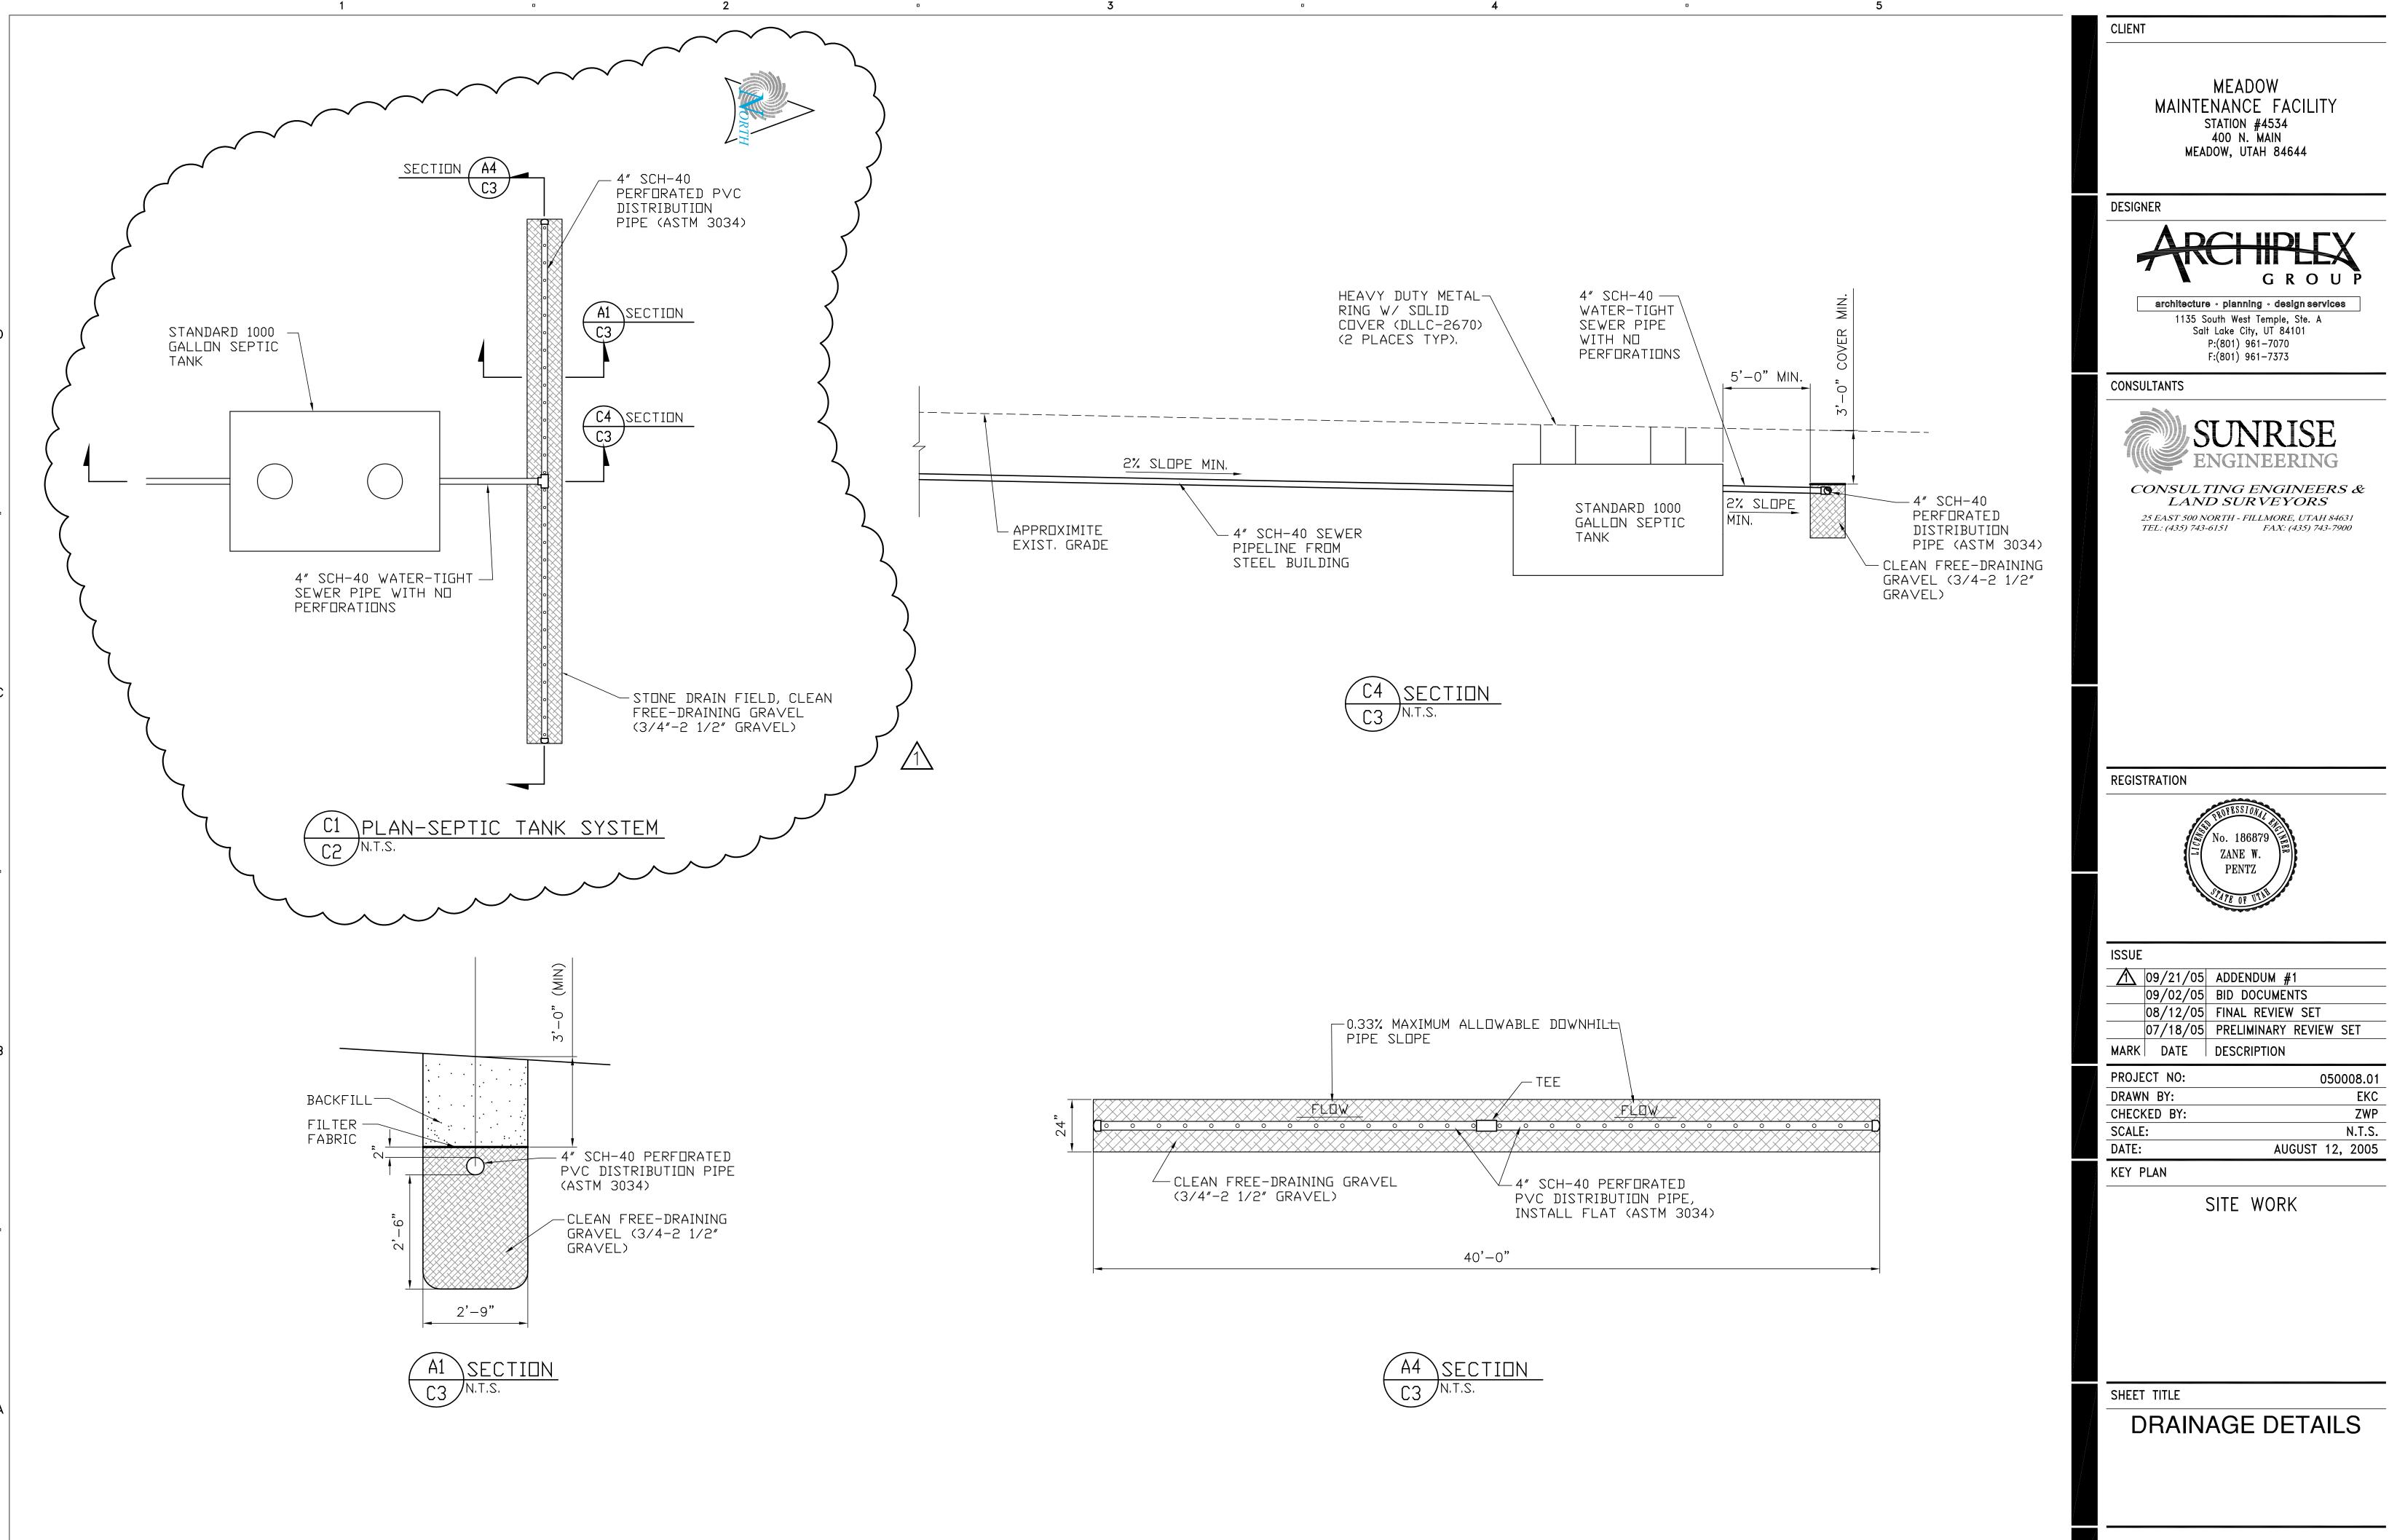


C003

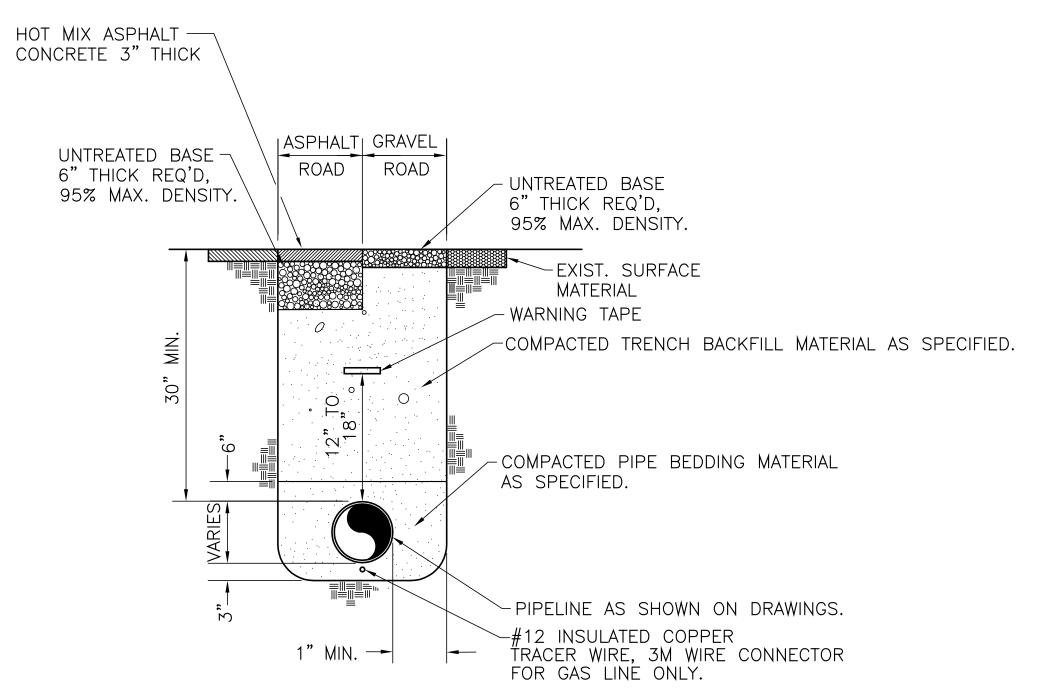


#### NOTE

- 1— TRENCH DETAIL APPLIES TO AREAS WITHIN ASPHALT / GRAVEL ROAD SURFACES, DRIVEWAYS, IRRIGATION DITCHES, AND ALL AREAS WHERE SURFACE IMPROVEMENTS MAY BE CONSTRUCTED.
- 2- EXISTING ASPHALT SHALL BE SAW CUT.



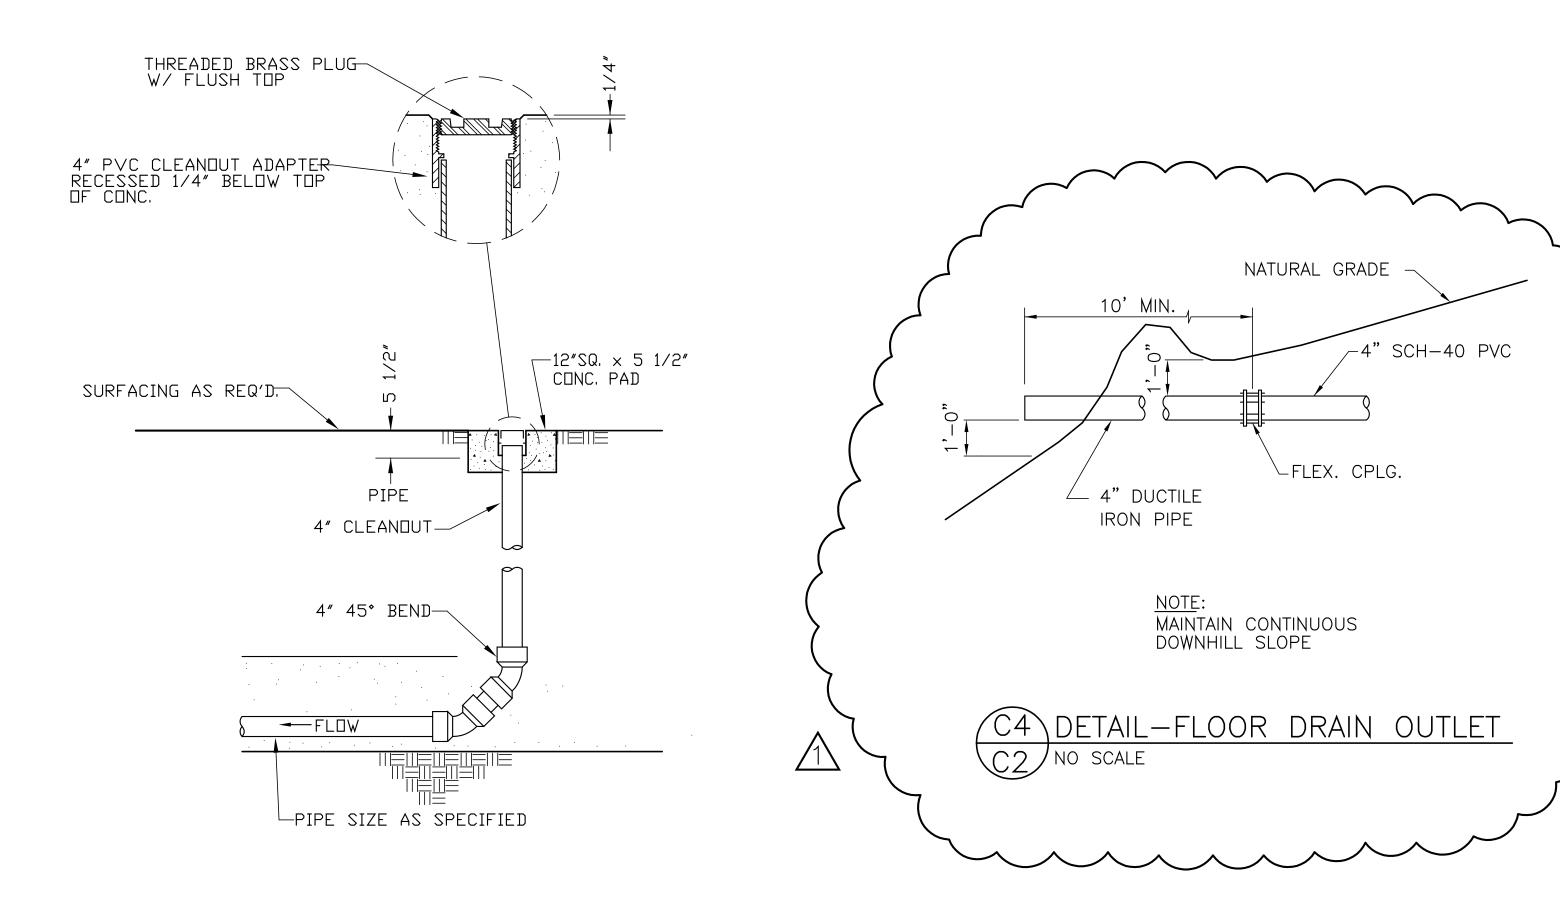



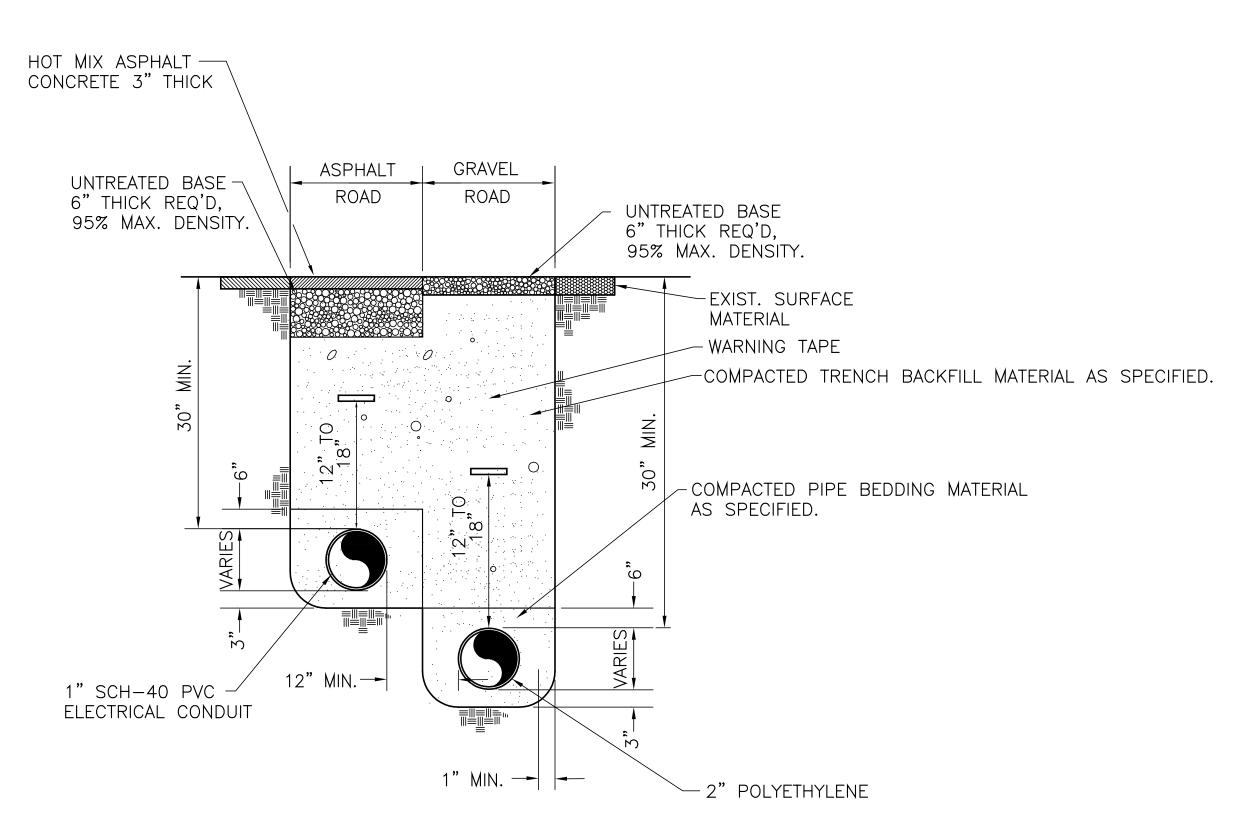

### NOTE:

- 1- TRENCH DETAIL APPLIES TO AREAS WITHIN ASPHALT / GRAVEL ROAD SURFACES, DRIVEWAYS, IRRIGATION DITCHES, AND ALL AREAS WHERE SURFACE IMPROVEMENTS MAY BE CONSTRUCTED.

  2- EXISTING ASPHALT SHALL BE SAW CUT.
  - A3 DETAIL—TRENCH UNDER ROAD SURFACE
    TYP NO SCALE

CLI

MEADOW
MAINTENANCE FACILITY
STATION #4534
400 N. MAIN
MEADOW, UTAH 84644

DESIGNER



architecture · planning · design services

1135 South West Temple, Ste. A
Salt Lake City, UT 84101
P:(801) 961-7070
F:(801) 961-7373


CONSULTANTS



CONSULTING ENGINEERS & LAND SUR VEYORS

25 EAST 500 NORTH - FILLMORE, UTAH 84631
TEL: (435) 743-6151 FAX: (435) 743-7900

REGISTRATION

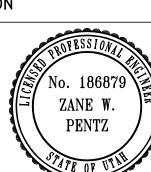

ISSUE

09/21/05 ADDENDUM #1

09/02/05 BID DOCUMENTS

08/12/05 FINAL REVIEW SET
07/18/05 PRELIMINARY REVIEW SET

MARK DATE DESCRIPTION

PROJECT NO: 050008.01

DRAWN BY: EKC

CHECKED BY: ZWP

SCALE: N.T.S.

KEY PLAN

DATE:

SITE WORK

AUGUST 12, 2005

SHEET TITLE

DRAINAGE & TRENCH DETAILS


C004


© 2004 ARCHIPLEX GROUP

3

2

5

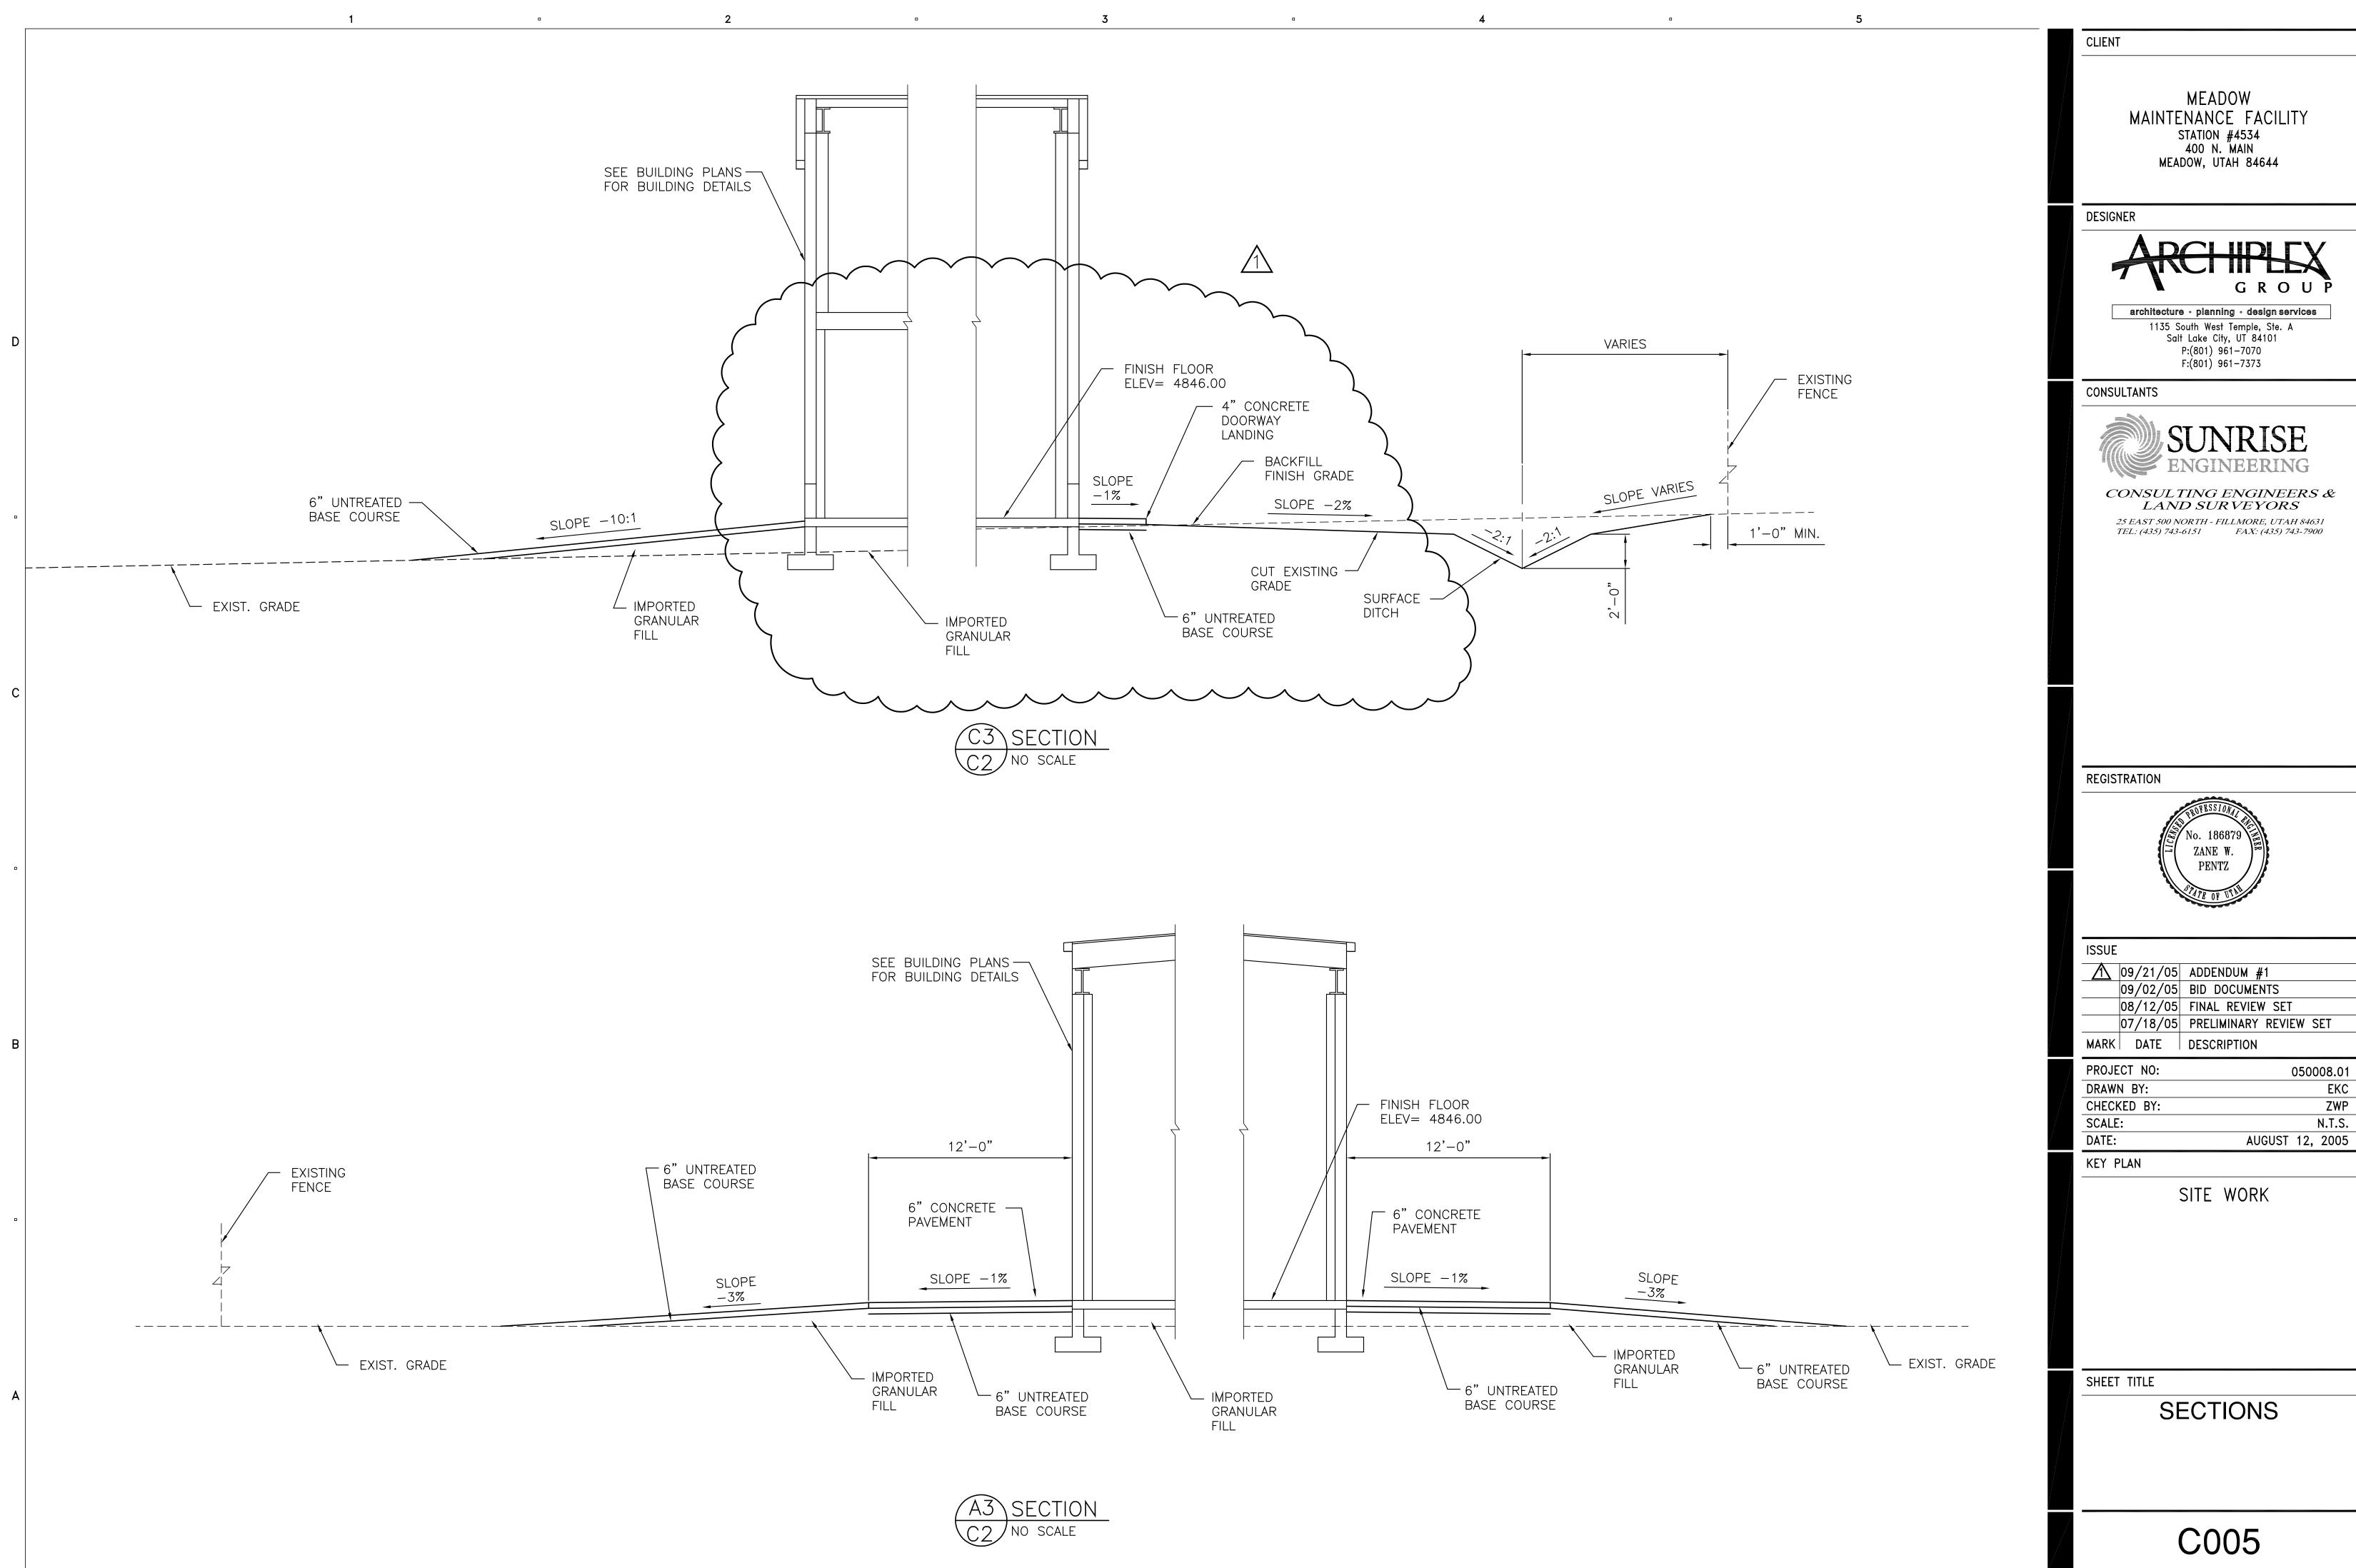

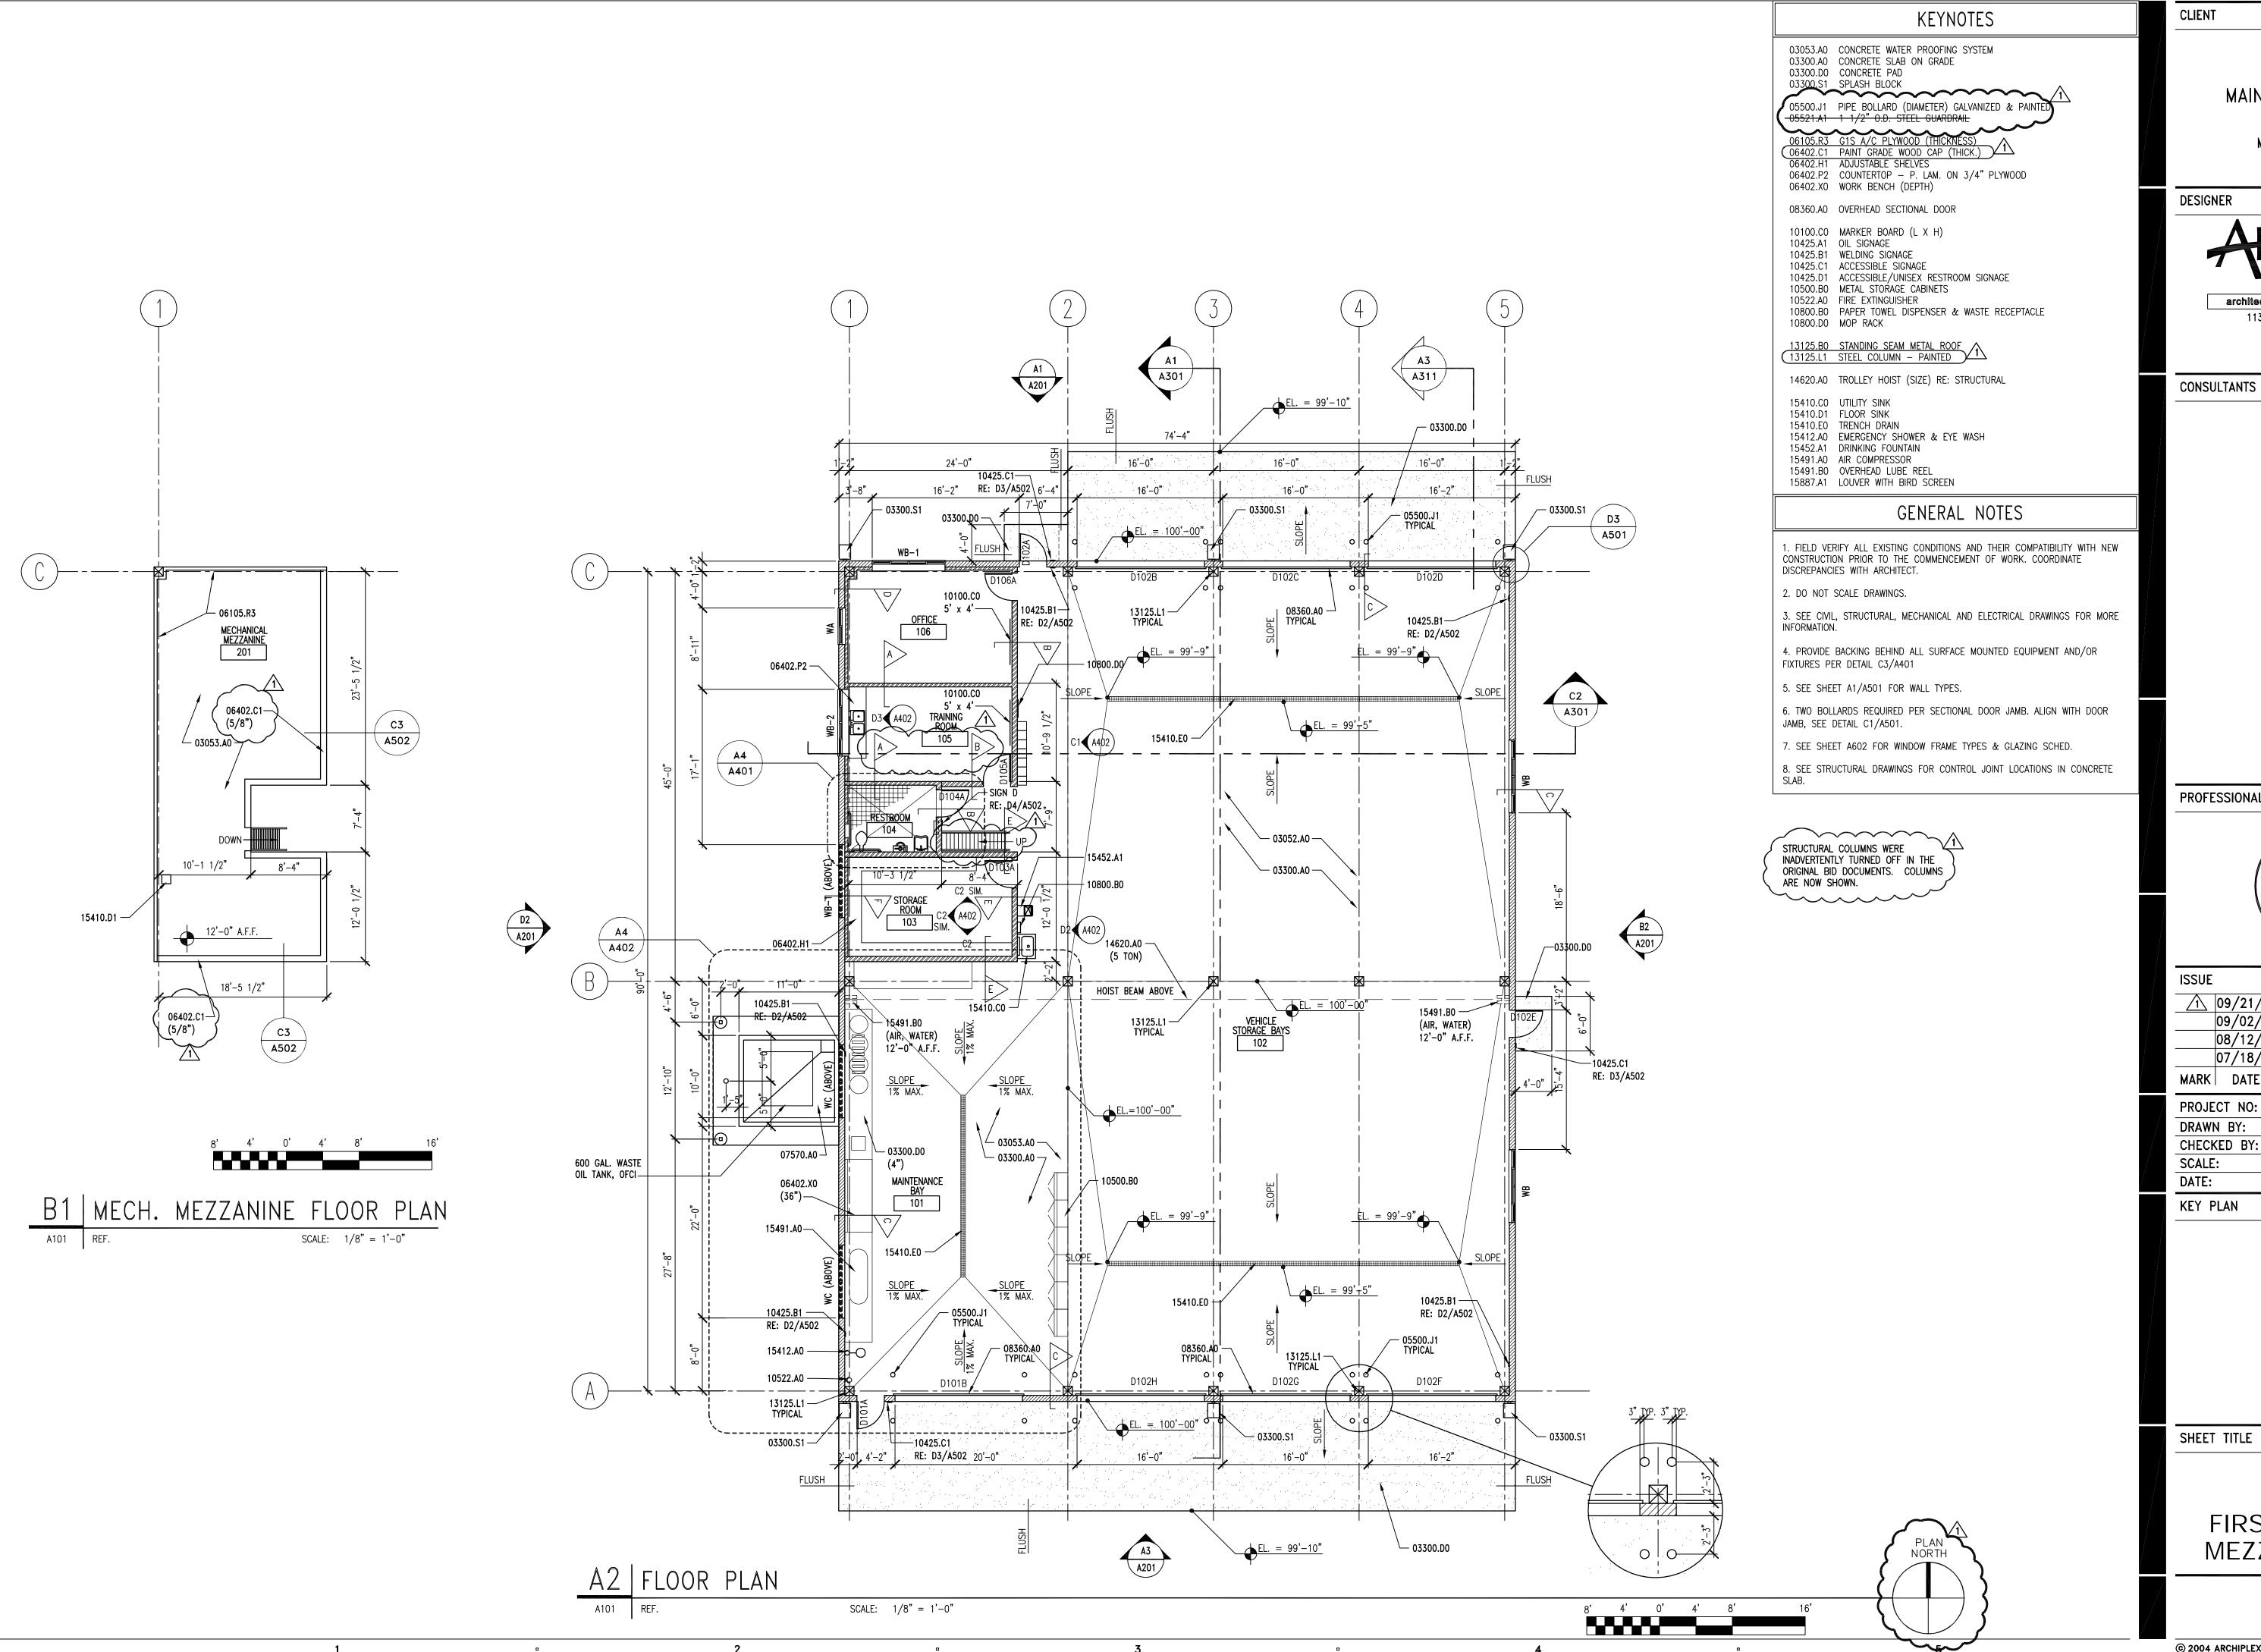

DESIGNER



architecture • planning • design services 1135 South West Temple, Ste. A Salt Lake City, UT 84101 P:(801) 961-7070 F:(801) 961-7373

CONSULTANTS

PROFESSIONAL SEAL



ISSUE		
	09/21/05	ADDENDUM #1
	09/02/05	BID DOCUMENTS
	08/12/05	FINAL REVIEW SET
	07/18/05	PRELIMINARY REVIEW SET
MARK	DATE	DESCRIPTION


SCALE:       1/8"=1'-0'         DATE:       SEPTEMBER 2, 2005	))
CHECKED DI: K. STANISLAY	•
CHECKED BY: R. STANISLAV	<u>,                                     </u>
DRAWN BY: K. PHILLIPS	3
PROJECT NO: 050008.0	1

KEY PLAN

SHEET TITLE


FIRST FLOOR AND MEZZANINE PLANS

A101

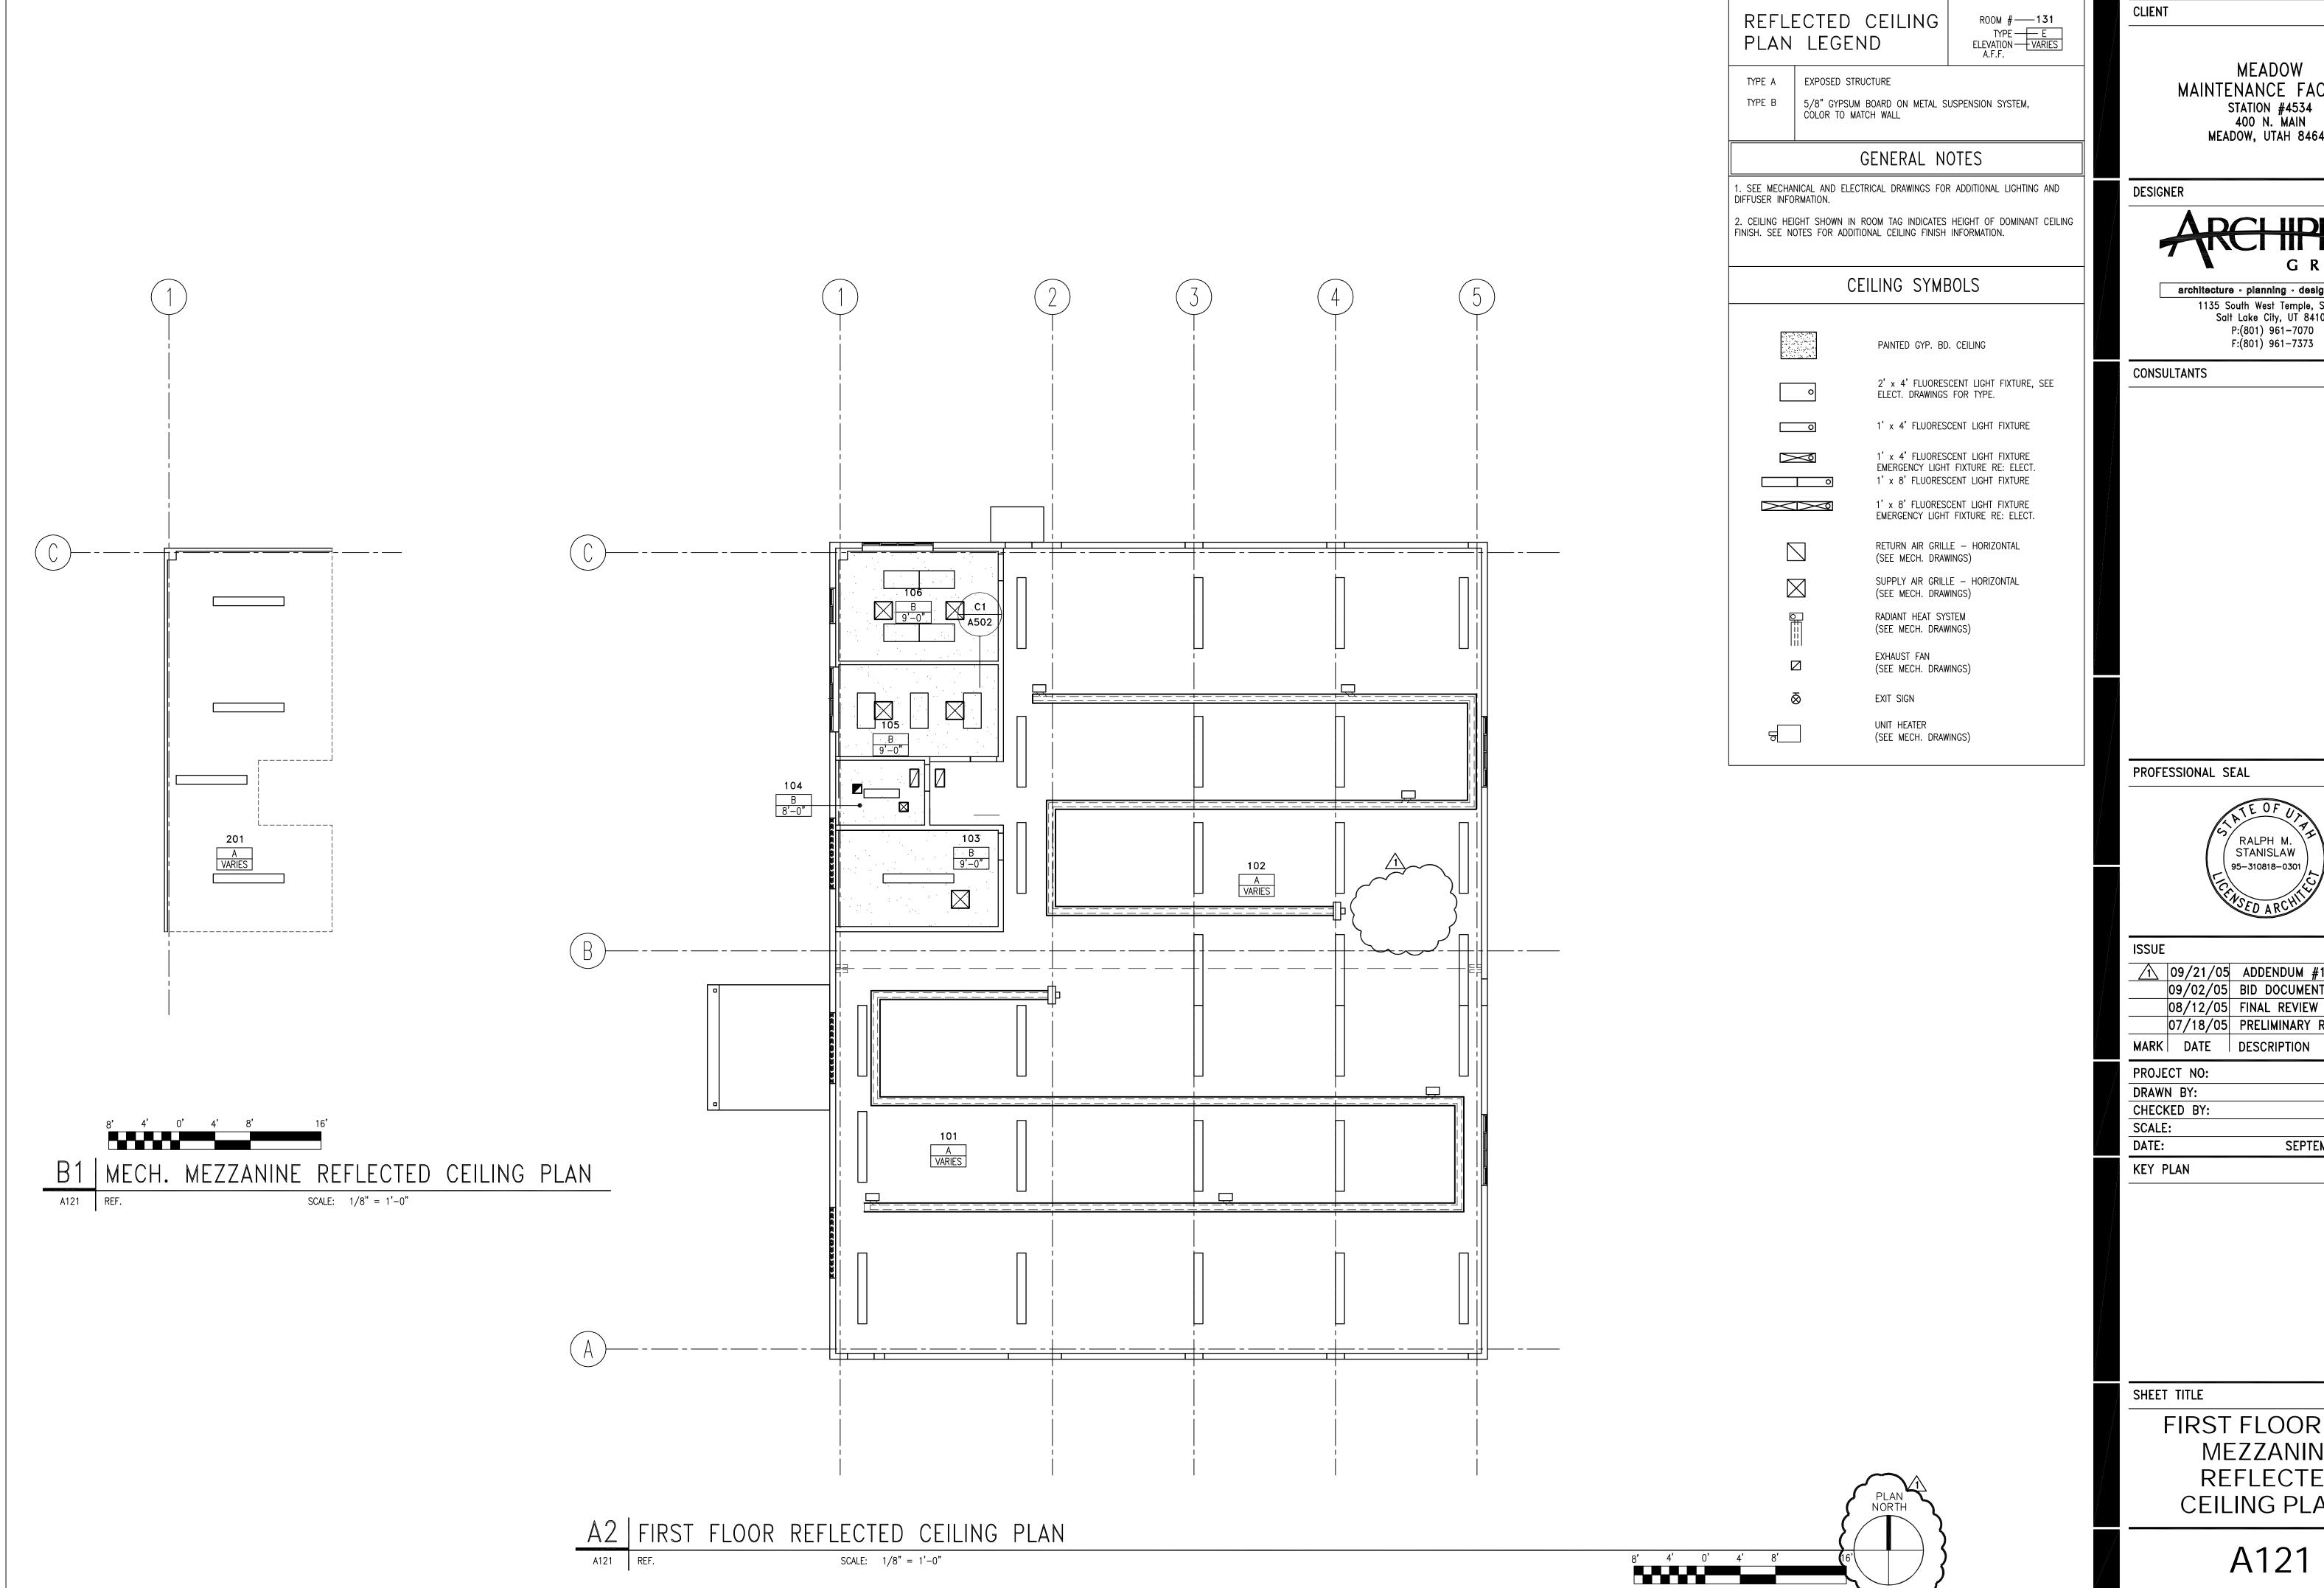




architecture • planning • design services 1135 South West Temple, Ste. A Salt Lake City, UT 84101

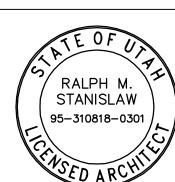


$\triangle$	09/21/05	ADDENDUM #1
	09/02/05	BID DOCUMENTS
	08/12/05	FINAL REVIEW SET
	07/18/05	PRELIMINARY REVIEW S

PROJECT NO:	050008.01
DRAWN BY:	K. PHILLIPS
CHECKED BY:	R. STANISLAW
SCALE:	1/8"=1'-0"
DATE:	SEPTEMBER 2, 2005

FIRST FLOOR AND MEZZANINE REFLECTED CEILING PLANS

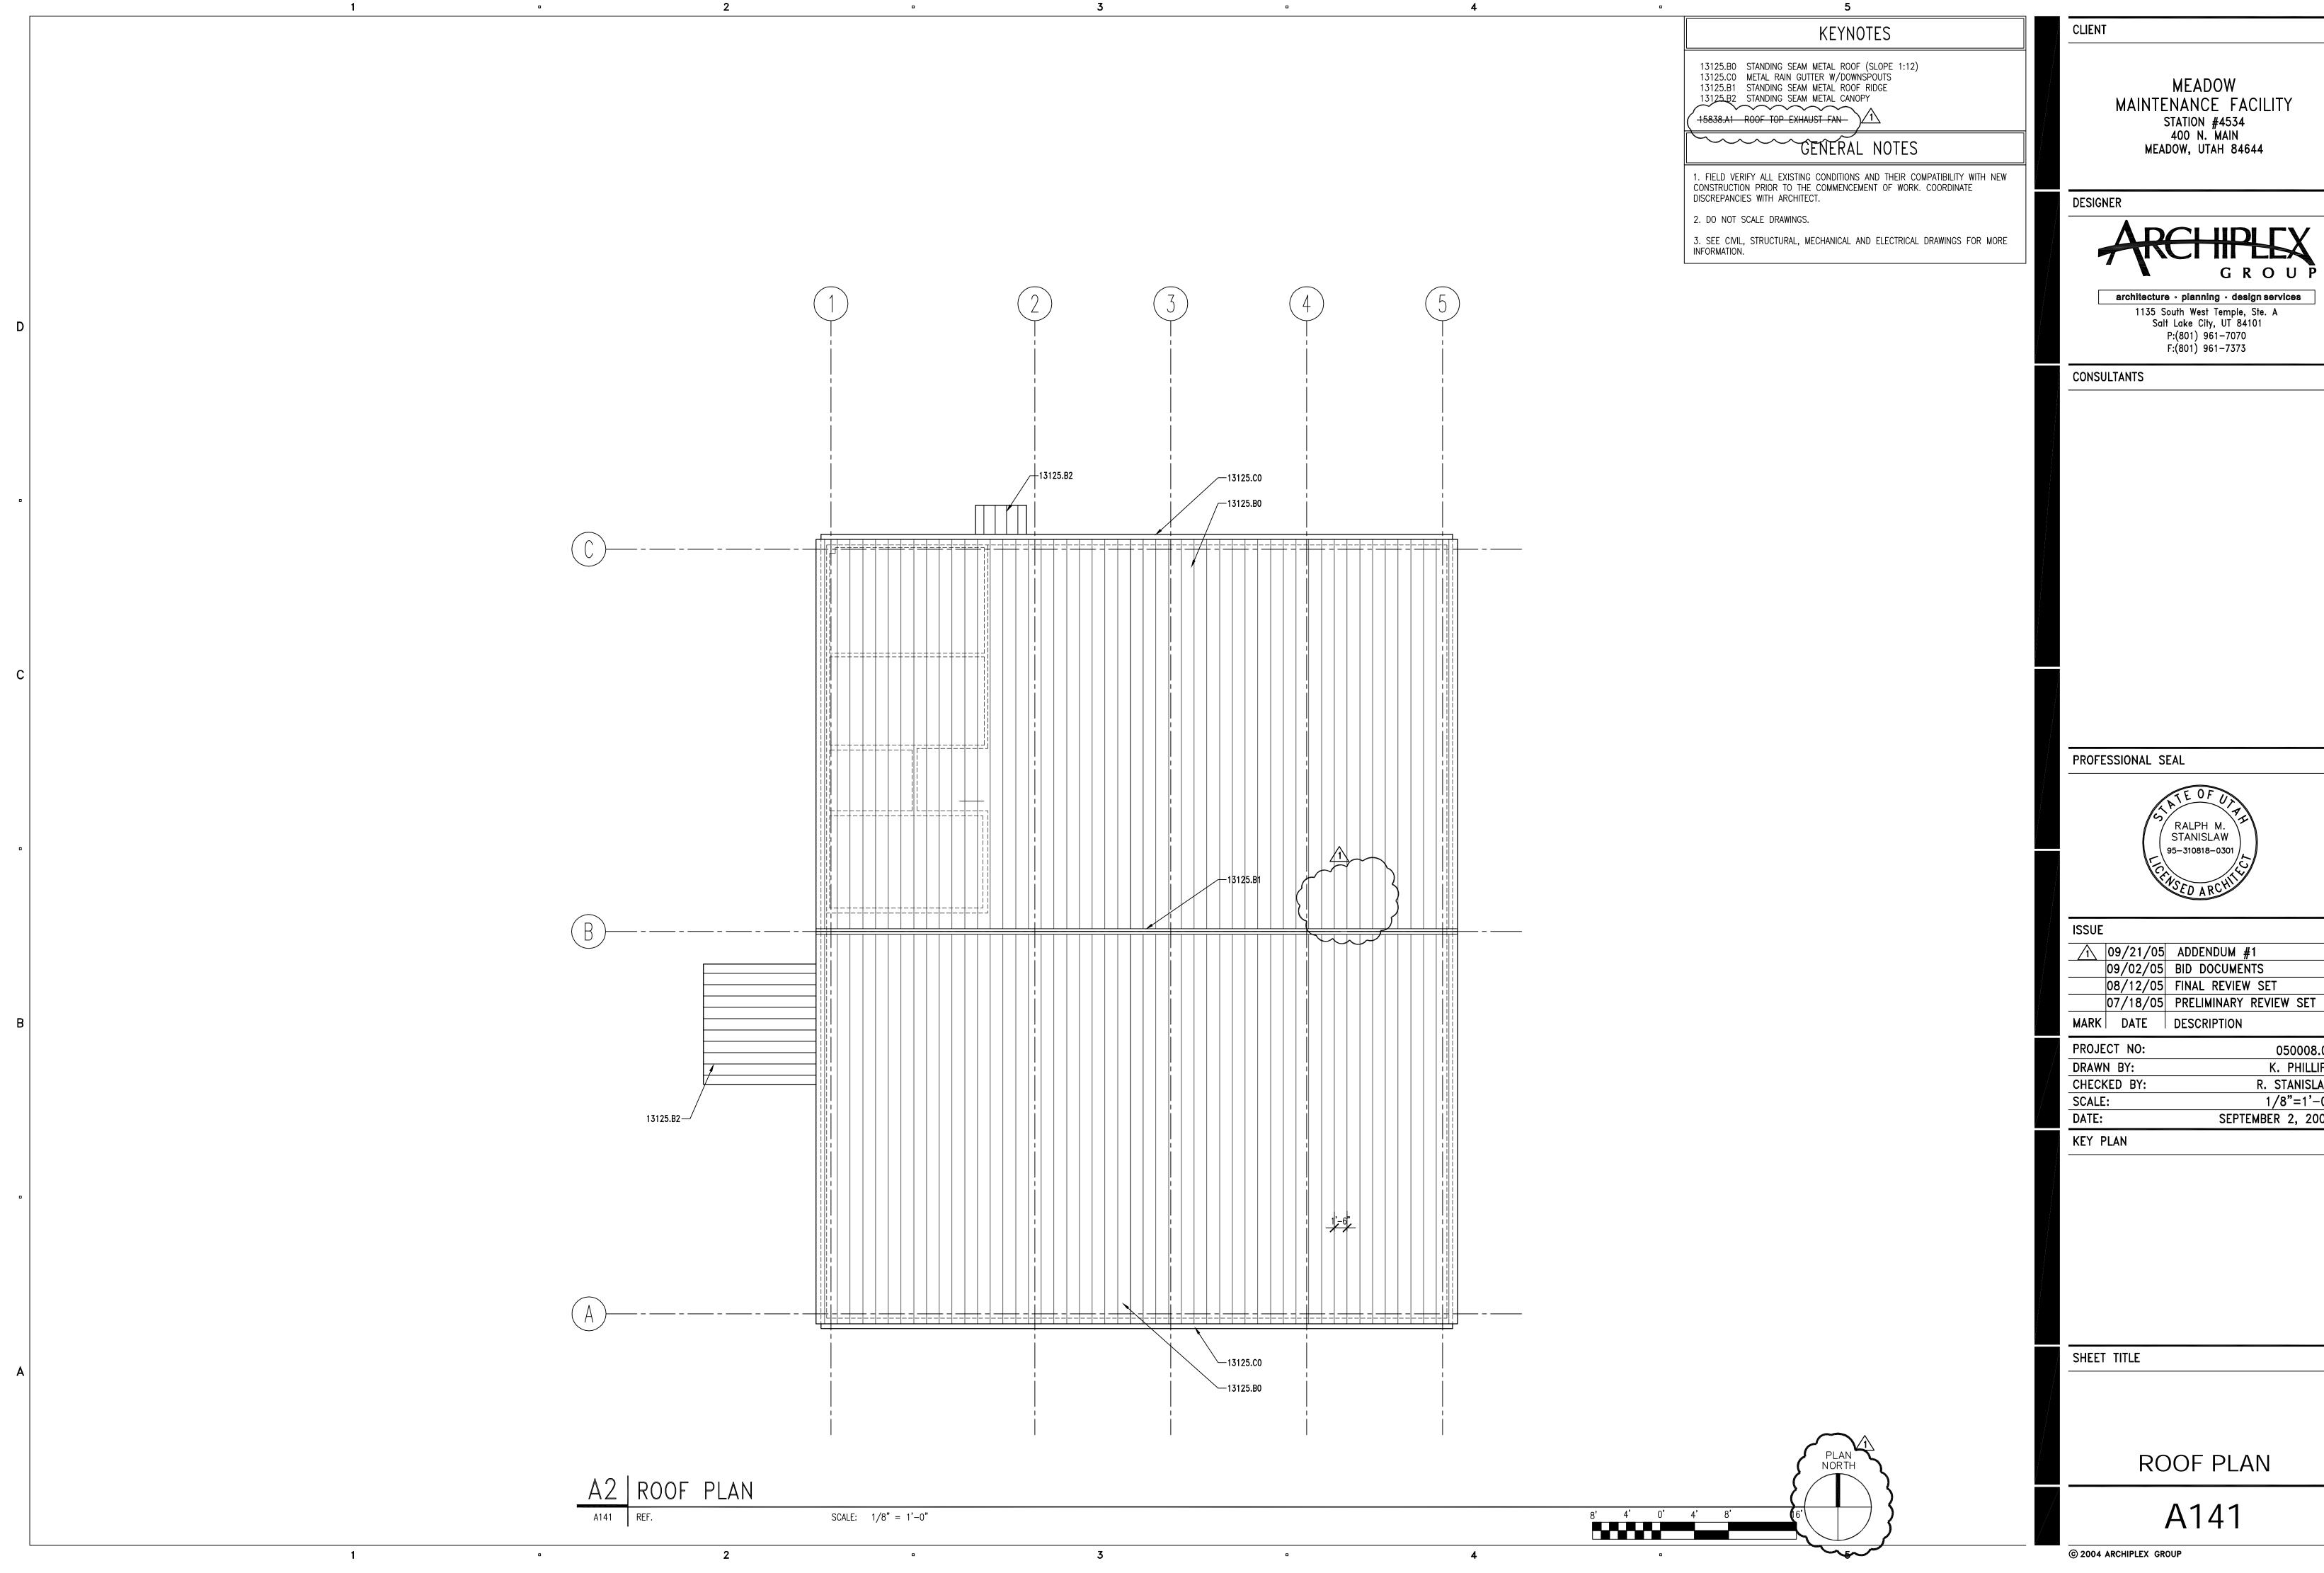

PROJECT NO:	050008.01
DRAWN BY:	K. PHILLIPS
CHECKED BY:	R. STANISLAW
SCALE:	1/8"=1'-0"
DATE:	SEPTEMBER 2, 2005

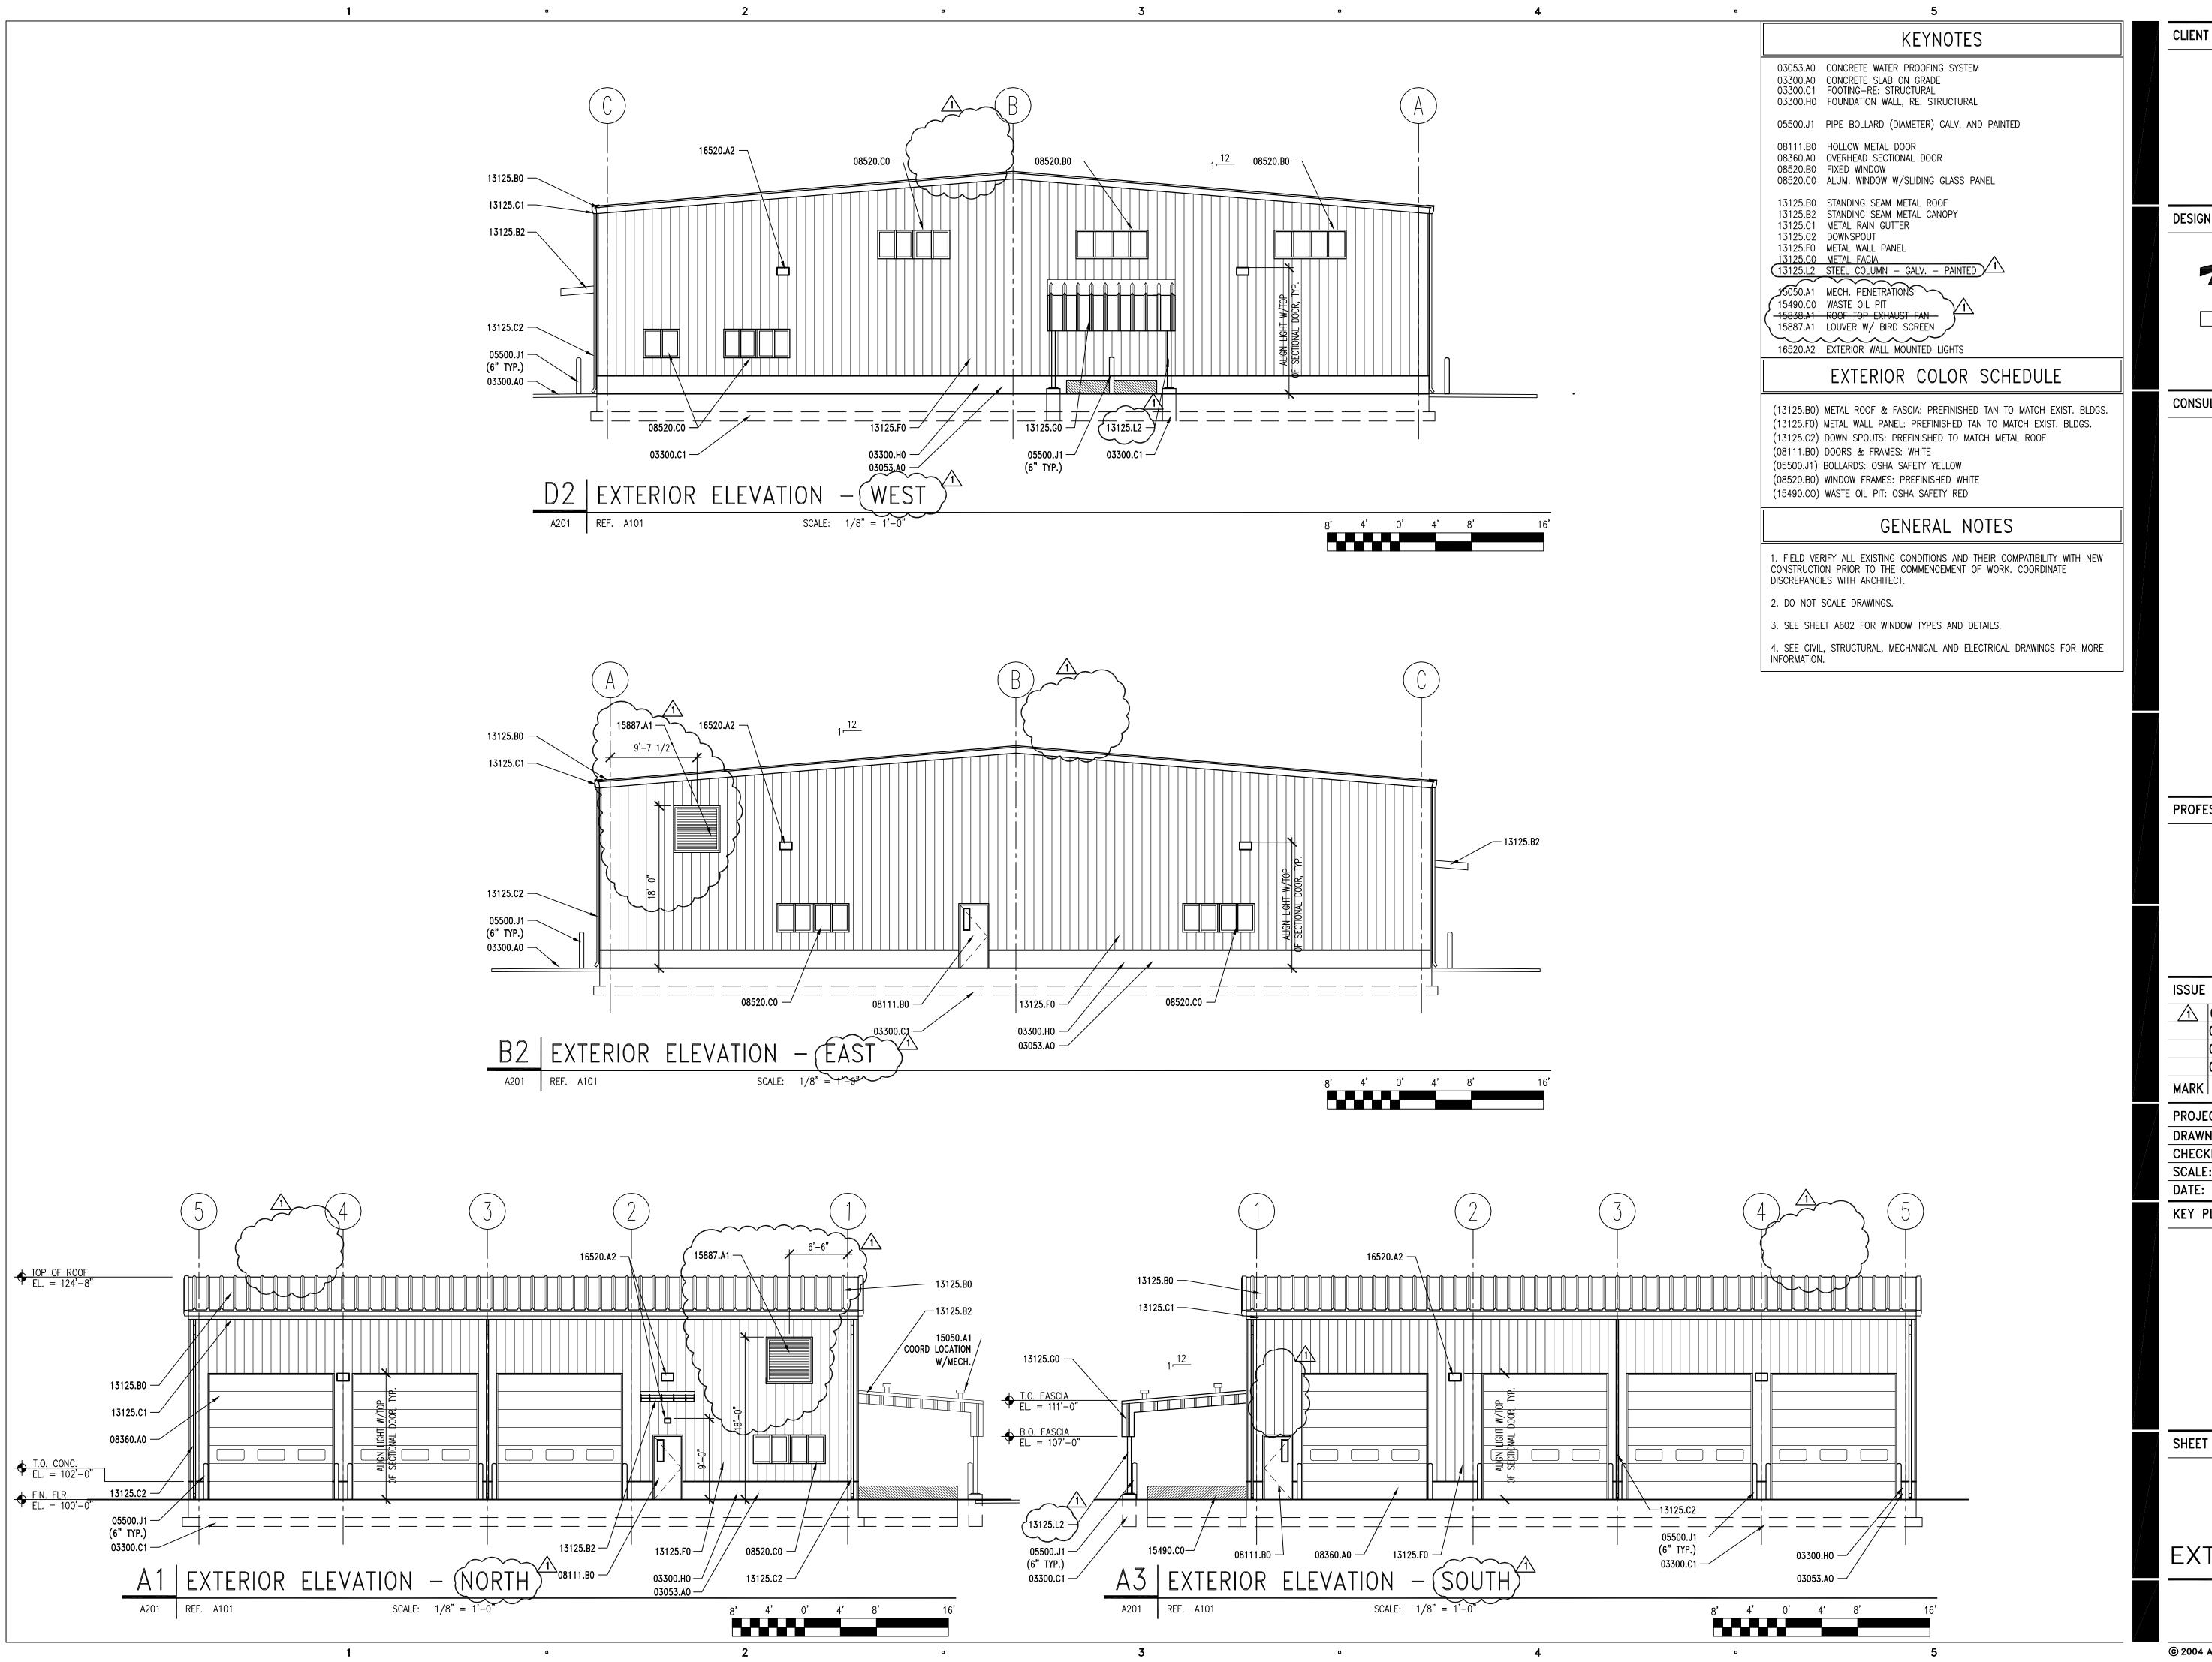


DESIGNER



architecture · planning · design services 1135 South West Temple, Ste. A Salt Lake City, UT 84101 P:(801) 961-7070 F:(801) 961-7373

CONSULTANTS

PROFESSIONAL SEAL

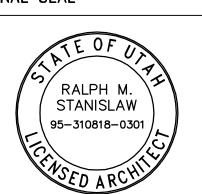

ISSUE		
1	09/21/05	ADDENDUM #1
	09/02/05	BID DOCUMENTS
	08/12/05	FINAL REVIEW SET
	07/18/05	PRELIMINARY REVIEW SET
MARK	DATE	DESCRIPTION


PROJECT NO:	050008.01
DRAWN BY:	K. PHILLIPS
CHECKED BY:	R. STANISLAW
SCALE:	1/8"=1'-0"
DATE:	SEPTEMBER 2, 2005


KEY PLAN

SHEET TITLE

**EXTERIOR ELEVATIONS** 

A201

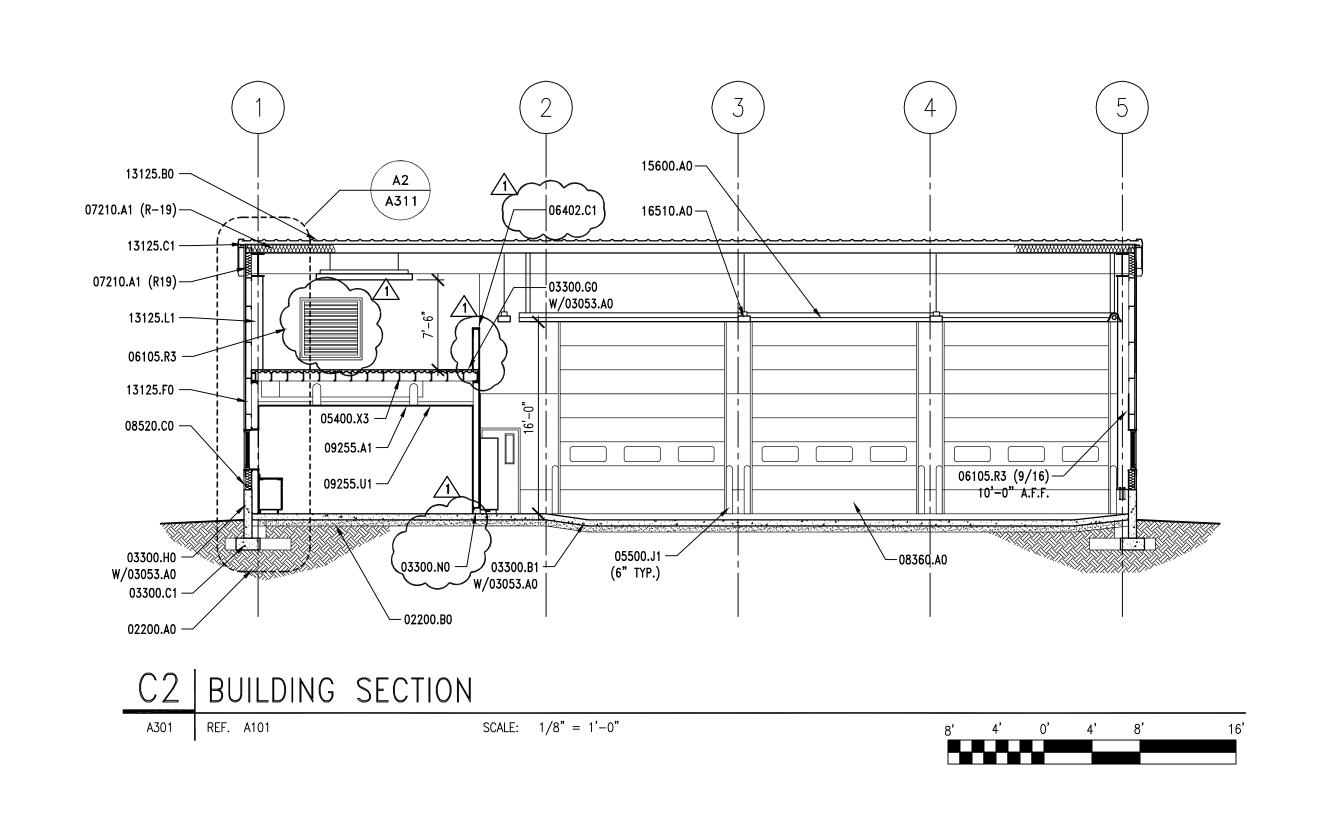

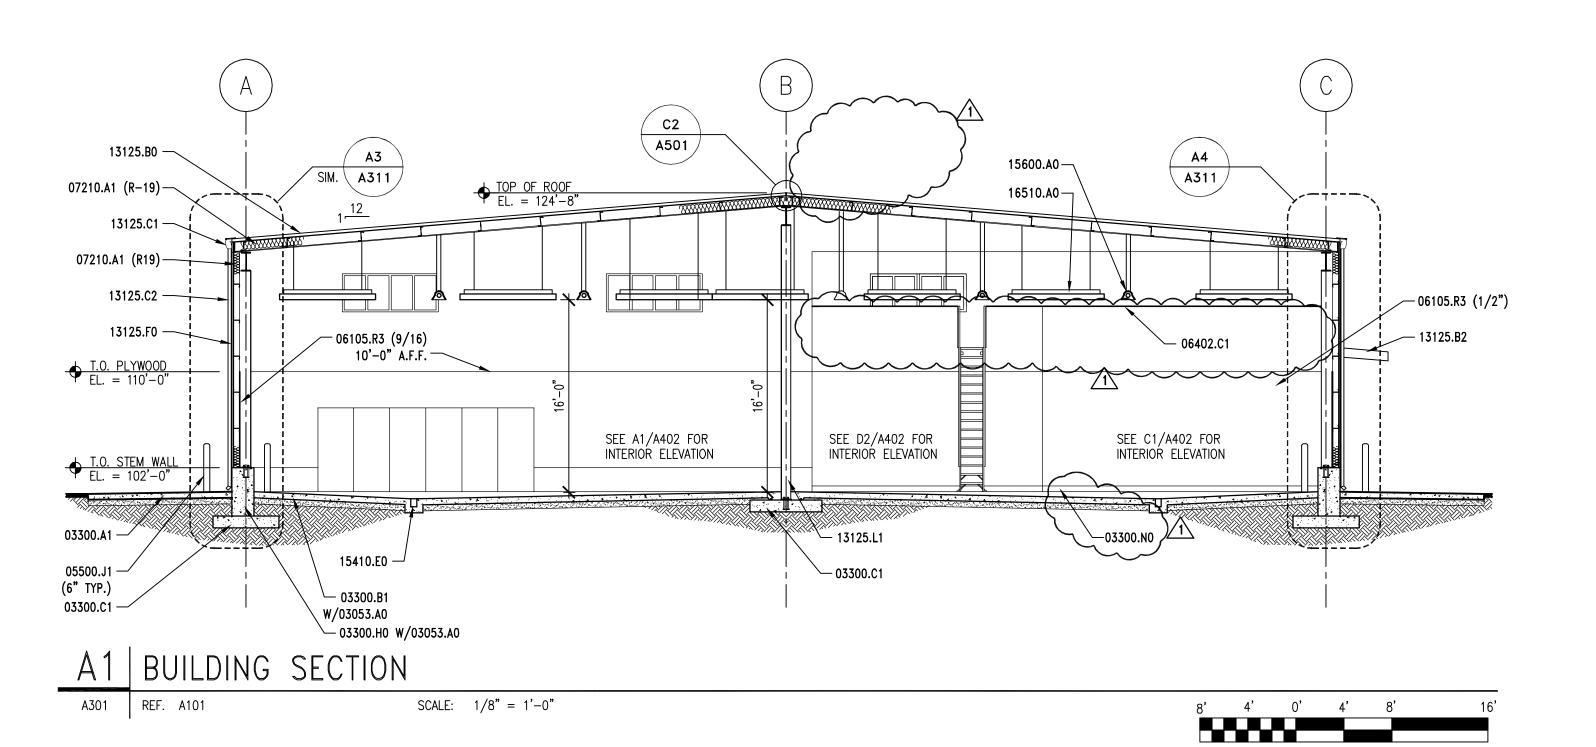

KEYNOTES

02200.A0 COMPACTED FILL 02200.B0 GRAVEL BASE

03053.A0 CONCRETE WATER PROOFING SYSTEM
03300.A1 CONCRETE SLAB-ON-GRADE - RE: STRUCTURAL

03300.B1 CONCRETE SLAB — RE: STRUCTURAL
03300.C1 FOOTING—RE: STRUCTURAL

03300.HO FOUNDATION WALL, RE: STRUCTURAL
03300.GO CONCRETE OVER METAL DECK — RE: STRUCTURAL
03300.NO CONCRETE CURB

03300.NO CONCRETE CURB

1 05500.J1 PIPE BOLLARD (DIAMETER) GALV. AND PAINTED

05521.A1 1 1/2" O.D. STEEL CUARDRAIL

06105.R3 G1S A/C PLYWOOD (THICKNESS)
06402.C1 PAINT GRADE WOOD CAP (THICK.)

07210.A1 BATT INSULATION (R-VALUE)

08360.A0 OVERHEAD SECTIONAL DOOR

08520.B0 FIXED WINDOW 08520.C0 ALUM. WINDOW W/SLIDING GLASS PANEL

09255.A1 GYPSUM BOARD (THICKNESS) 09255.U1 SUSPENDED CEILING SYSTEM

13125.B0 STANDING SEAM METAL ROOF 13125.B2 STANDING SEAM METAL CANOPY

13125.C1 METAL RAIN GUTTER 13125.C2 DOWNSPOUT

13125.E3 RAKE TRIM 13125.F0 METAL WALL PANEL

13125.L1 STEEL COLUMN - PAINTED

15410.EO TRENCH DRAIN
15600.AO NATURAL GAS RADIANT HEATING SYSTEM
15838.A1 ROOF TOP EXHAUST FAN

16510.A0 INTERIOR LIGHTS

# GENERAL NOTES

1. FIELD VERIFY ALL EXISTING CONDITIONS AND THEIR COMPATIBILITY WITH NEW CONSTRUCTION PRIOR TO THE COMMENCEMENT OF WORK. COORDINATE DISCREPANCIES WITH ARCHITECT.

2. DO NOT SCALE DRAWINGS.

3. SEE SHEET A602 FOR WINDOW TYPES AND DETAILS.

4. SEE CIVIL, STRUCTURAL, MECHANICAL AND ELECTRICAL DRAWINGS FOR MORE INFORMATION.

CLIENT

MEADOW
MAINTENANCE FACILITY
STATION #4534
400 N. MAIN
MEADOW, UTAH 84644

DESIGNER




architecture • planning • design services

1135 South West Temple, Ste. A
Salt Lake City, UT 84101
P:(801) 961-7070

F:(801) 961-7373

CONSULTANTS

PROFESSIONAL SEAL

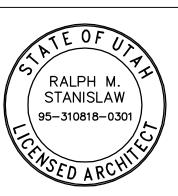

ISSUE		
		ADDENDUM #1
	09/02/05	BID DOCUMENTS
	08/12/05	FINAL REVIEW SET
	07/18/05	PRELIMINARY REVIEW SET

MARK DATE DESCRIPTION


PROJECT NO:	050008.01
DRAWN BY:	K. PHILLIPS
CHECKED BY:	R. STANISLAW
SCALE:	1/8"=1'-0"
DATE:	SEPTEMBER 2, 2005

KEY PLAN


SHEET TITLE

**BUILDING SECTIONS** 

A301

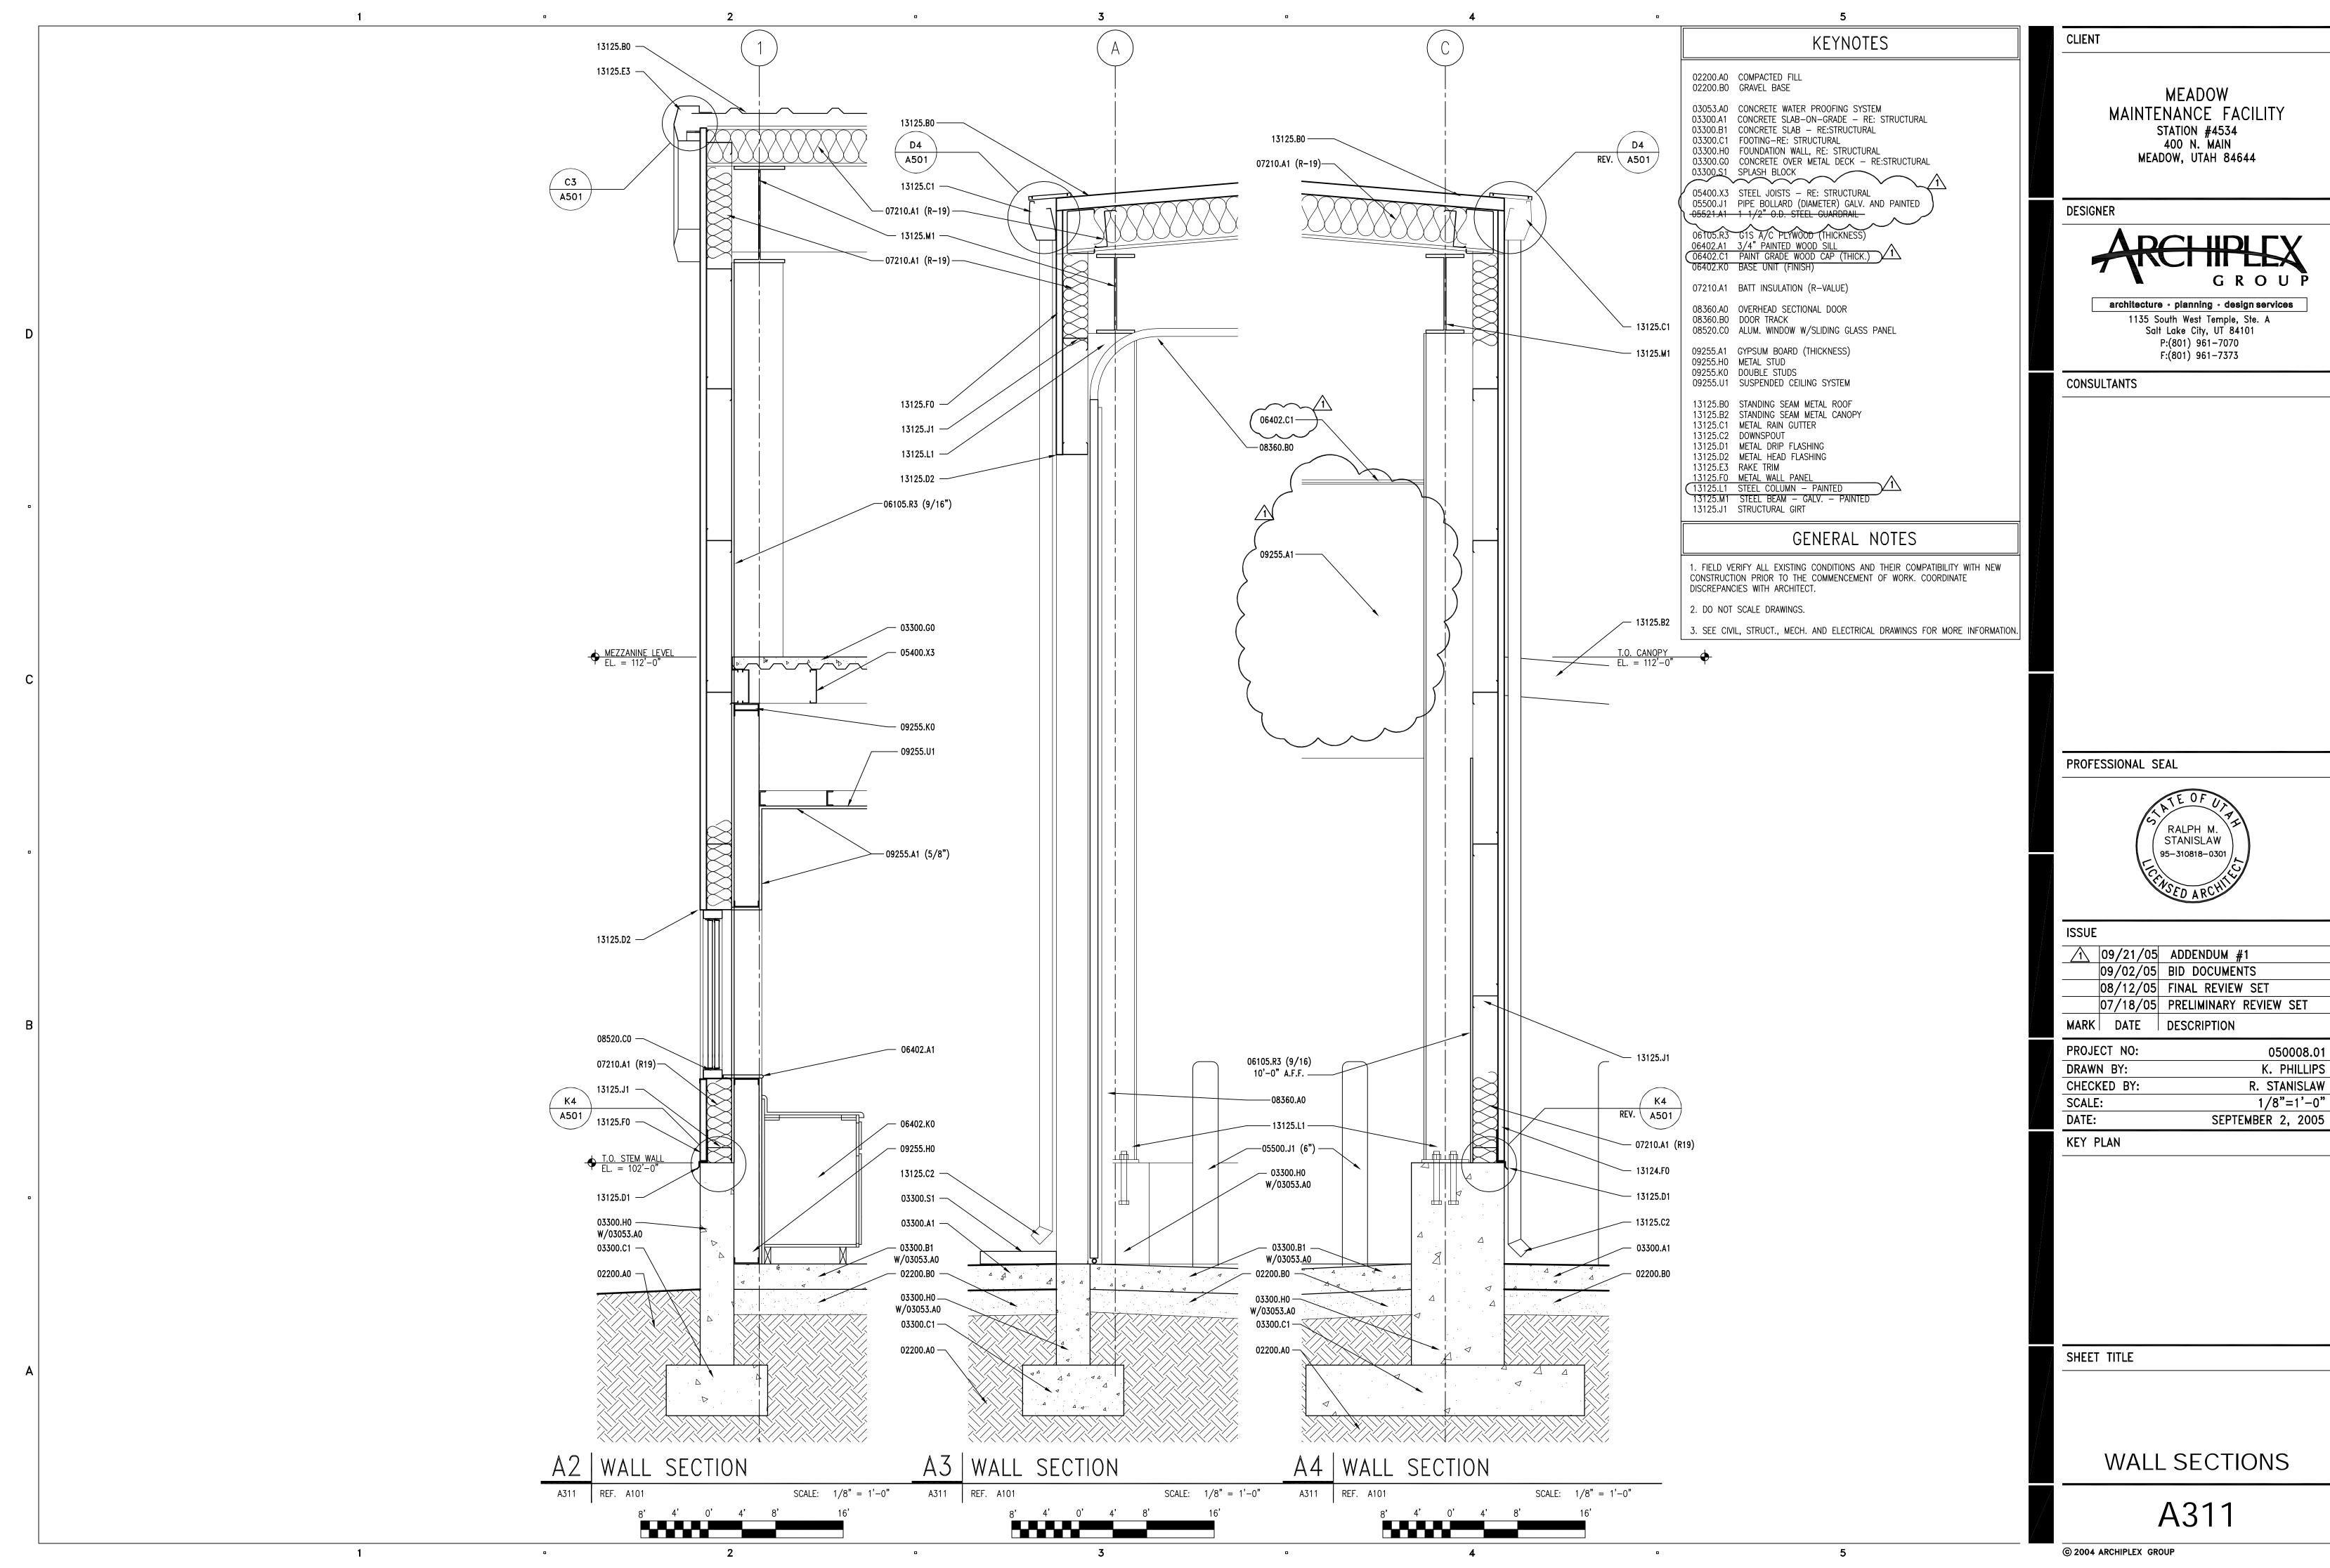

DRAWN BY:	K. PHILLIPS
CHECKED BY:	R. STANISLAW
SCALE:	1/8"=1'-0"
DATE:	SEPTEMBER 2, 2005
KEY PLAN	

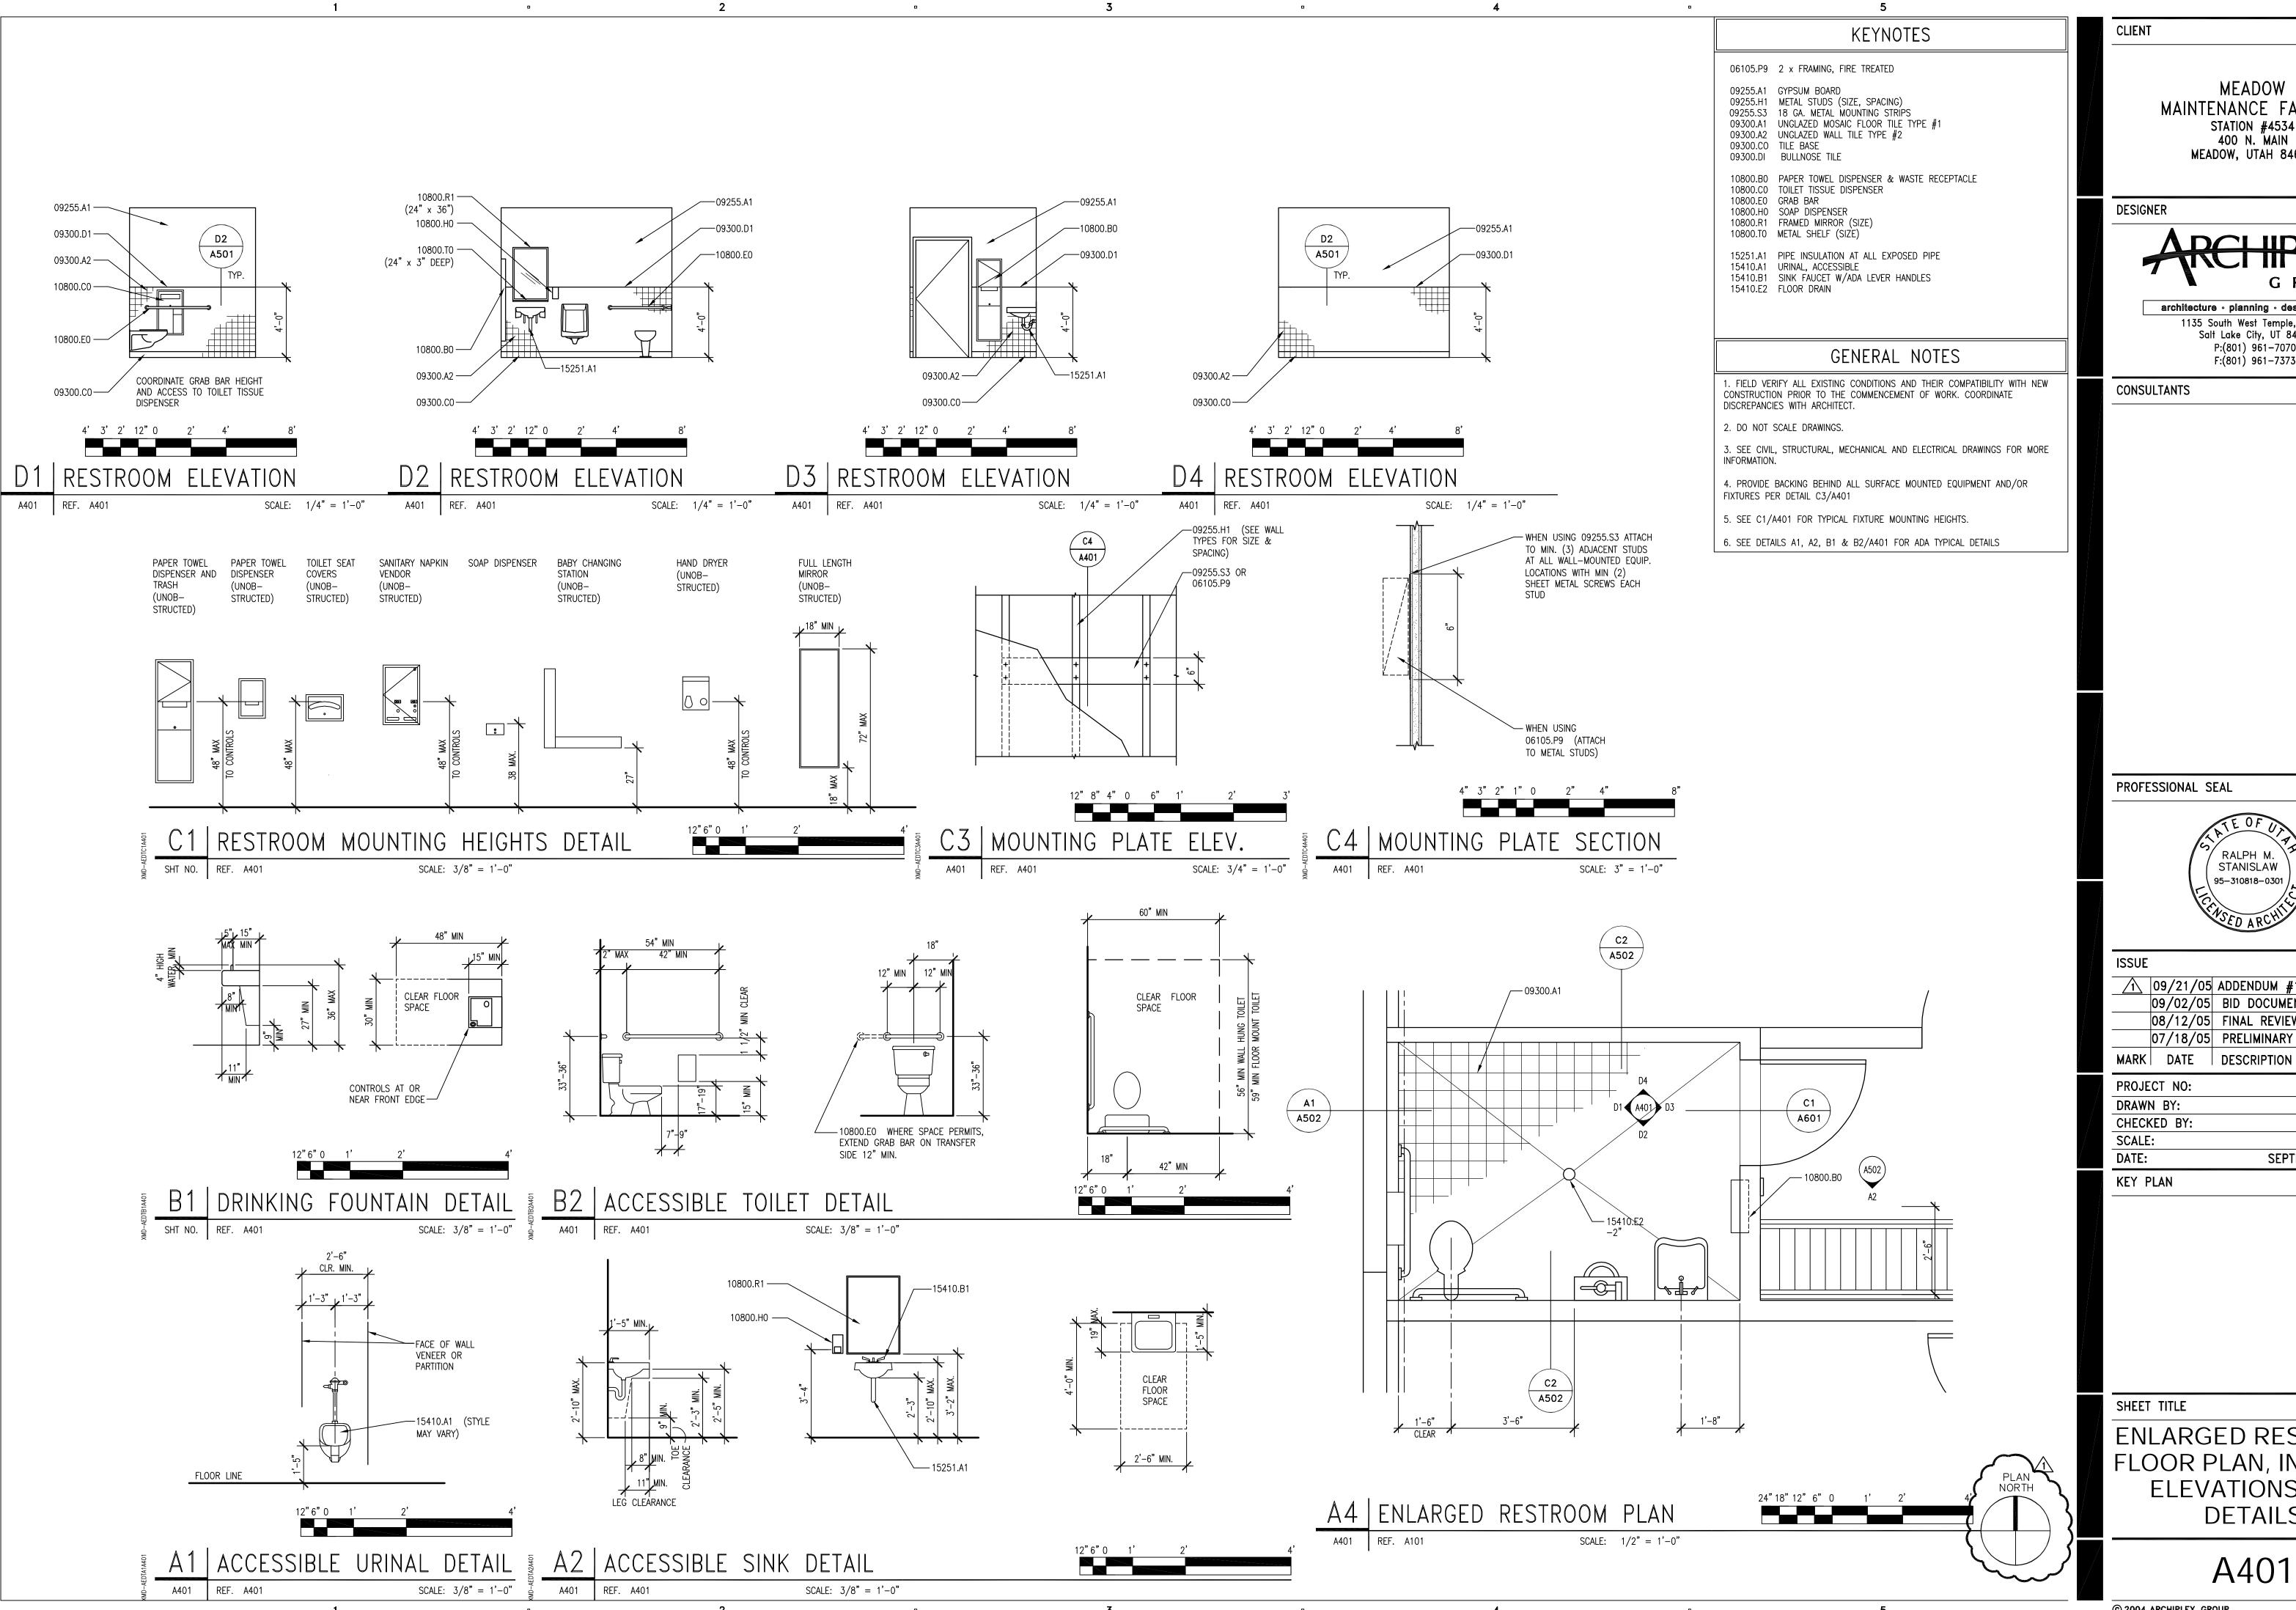


DESIGNER



architecture • planning • design services 1135 South West Temple, Ste. A Salt Lake City, UT 84101 P:(801) 961-7070 F:(801) 961-7373

CONSULTANTS

PROFESSIONAL SEAL

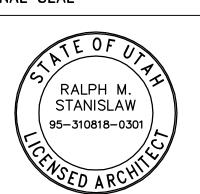

ISSUE			
		ADDENDUM #1	
	09/02/05	BID DOCUMENTS	
	08/12/05	FINAL REVIEW SET	
	07/18/05	PRELIMINARY REVIEW S	SET


PROJECT NO:	050008.01
DRAWN BY:	K. PHILLIPS
CHECKED BY:	R. STANISLAW
SCALE:	AS SHOWN
DATE:	SEPTEMBER 2, 2005

KEY PLAN


SHEET TITLE

ENLARGED RESTROOM FLOOR PLAN, INTERIOR **ELEVATIONS AND DETAILS** 

A401

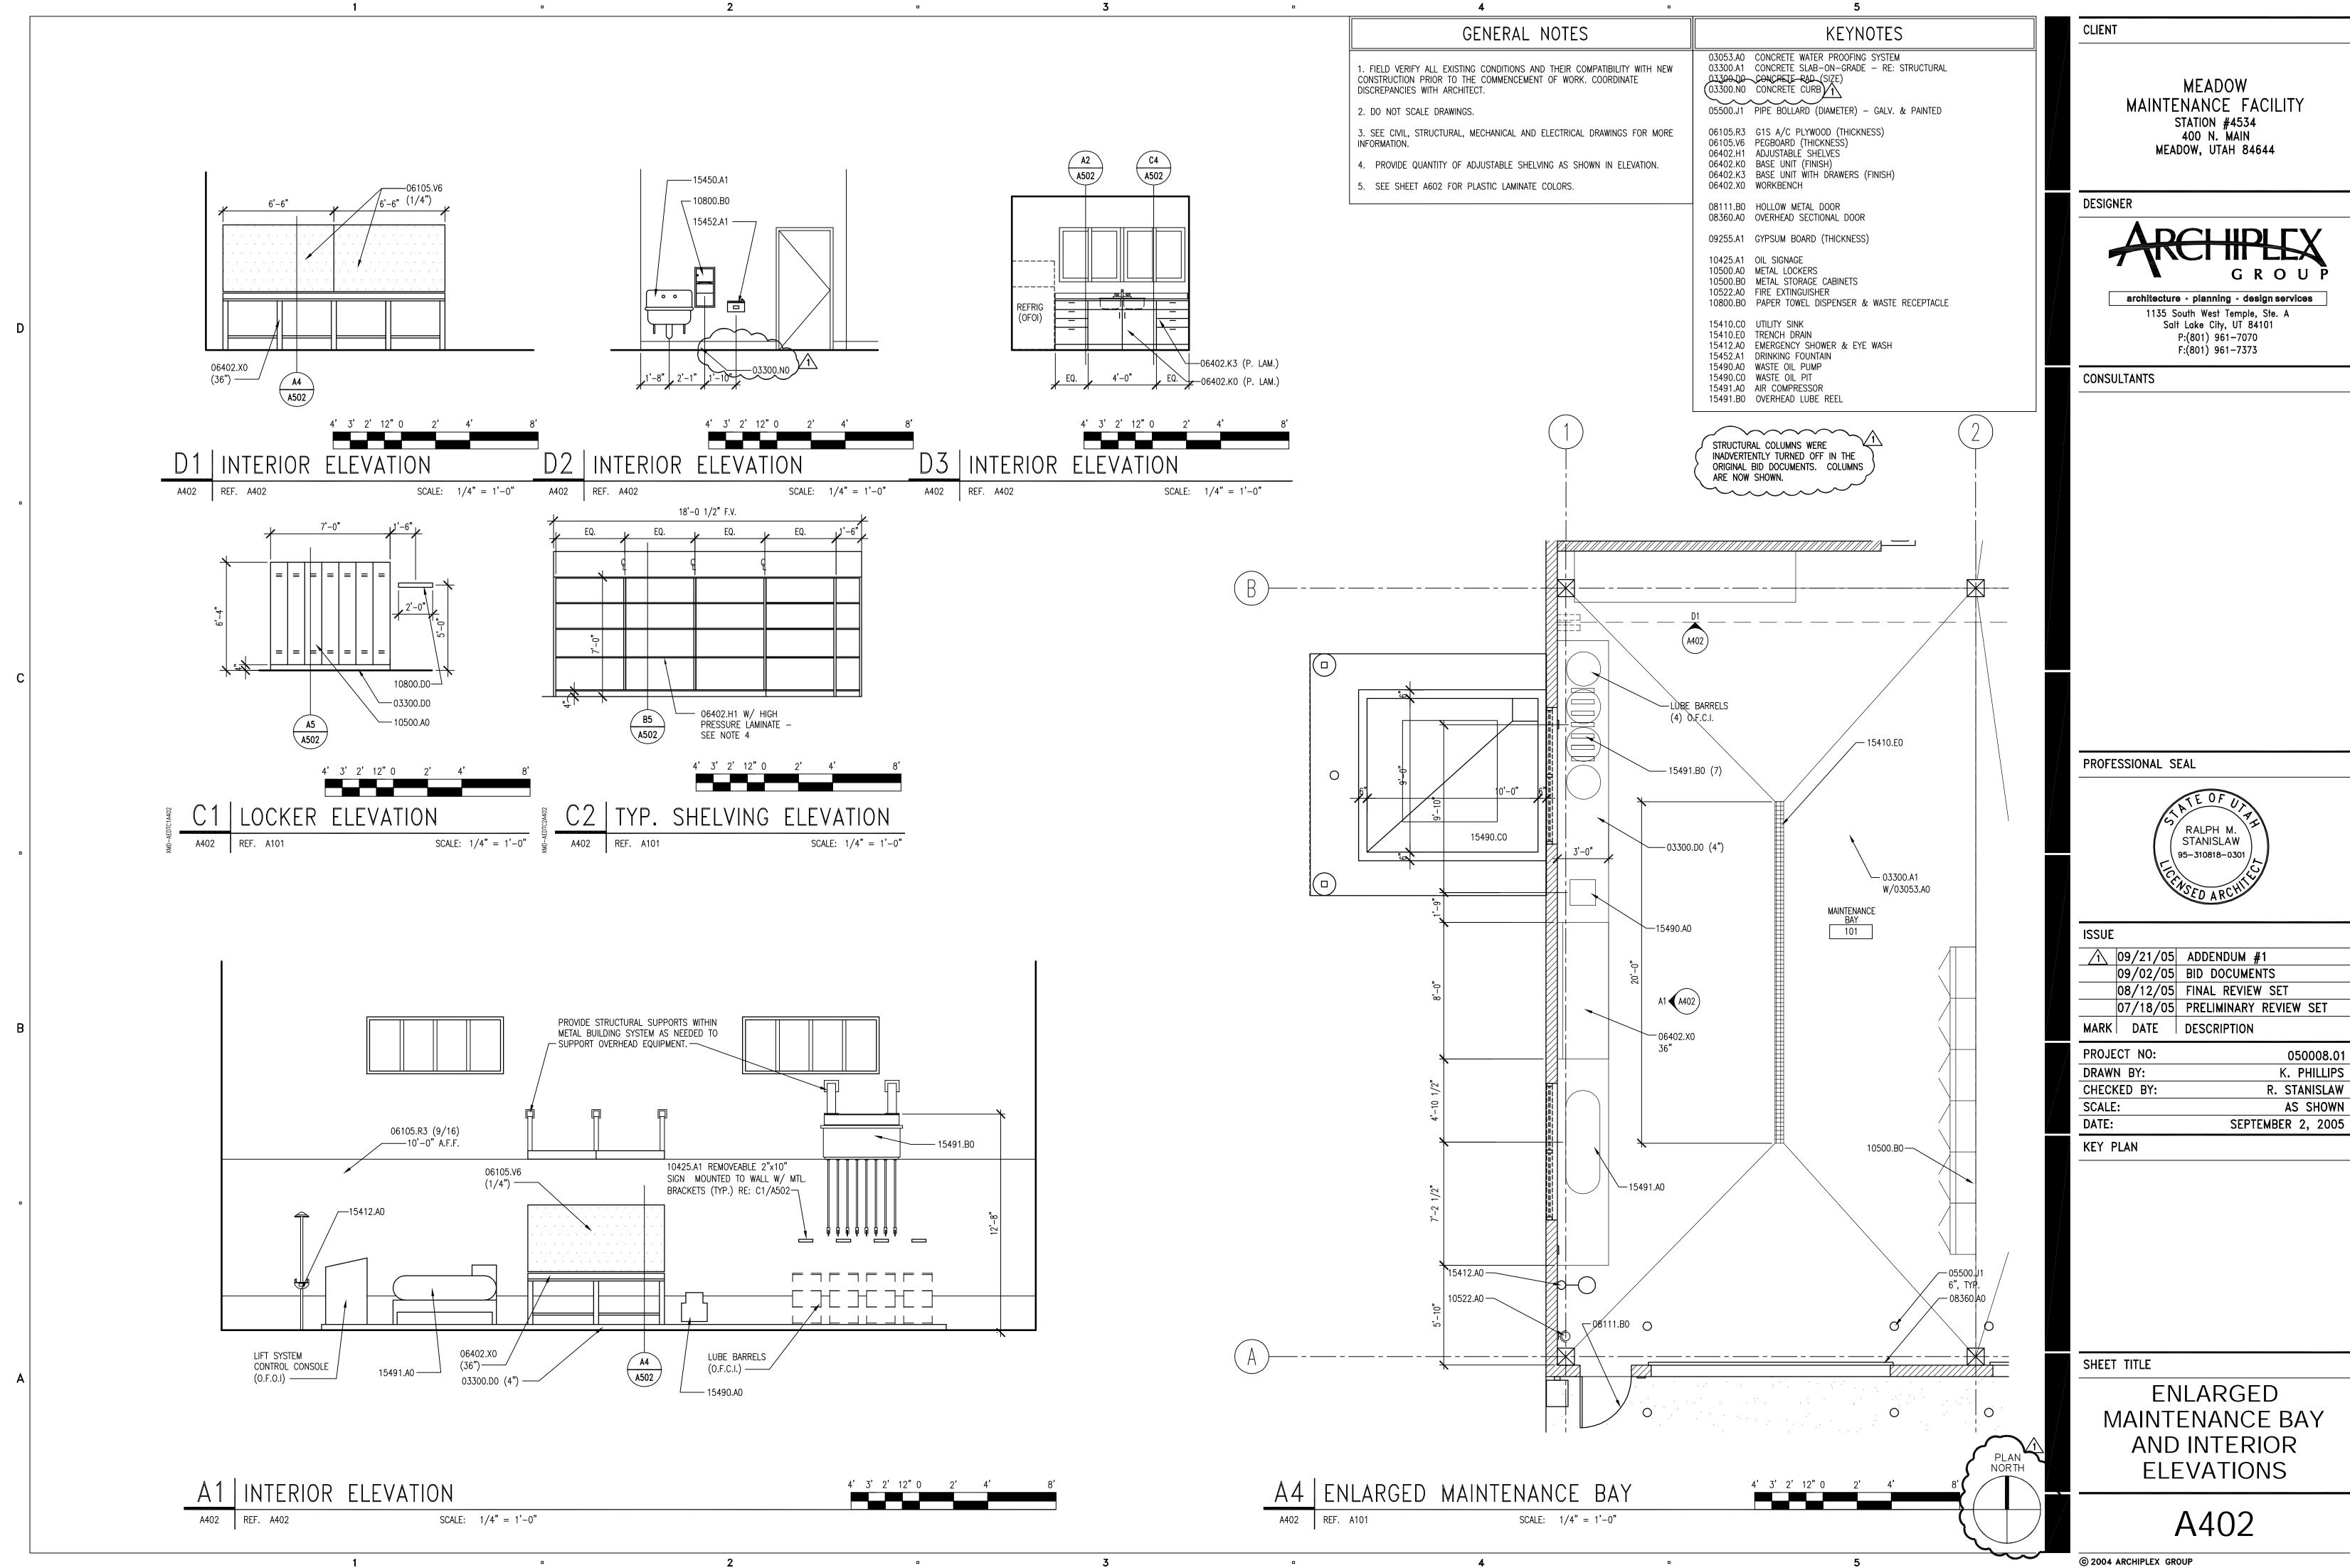


LIEV DI ANI	
DATE:	SEPTEMBER 2, 2005
SCALE:	AS SHOWN
CHECKED BY:	R. STANISLAW
DRAWN BY:	K. PHILLIPS
PROJECT NO:	050008.01

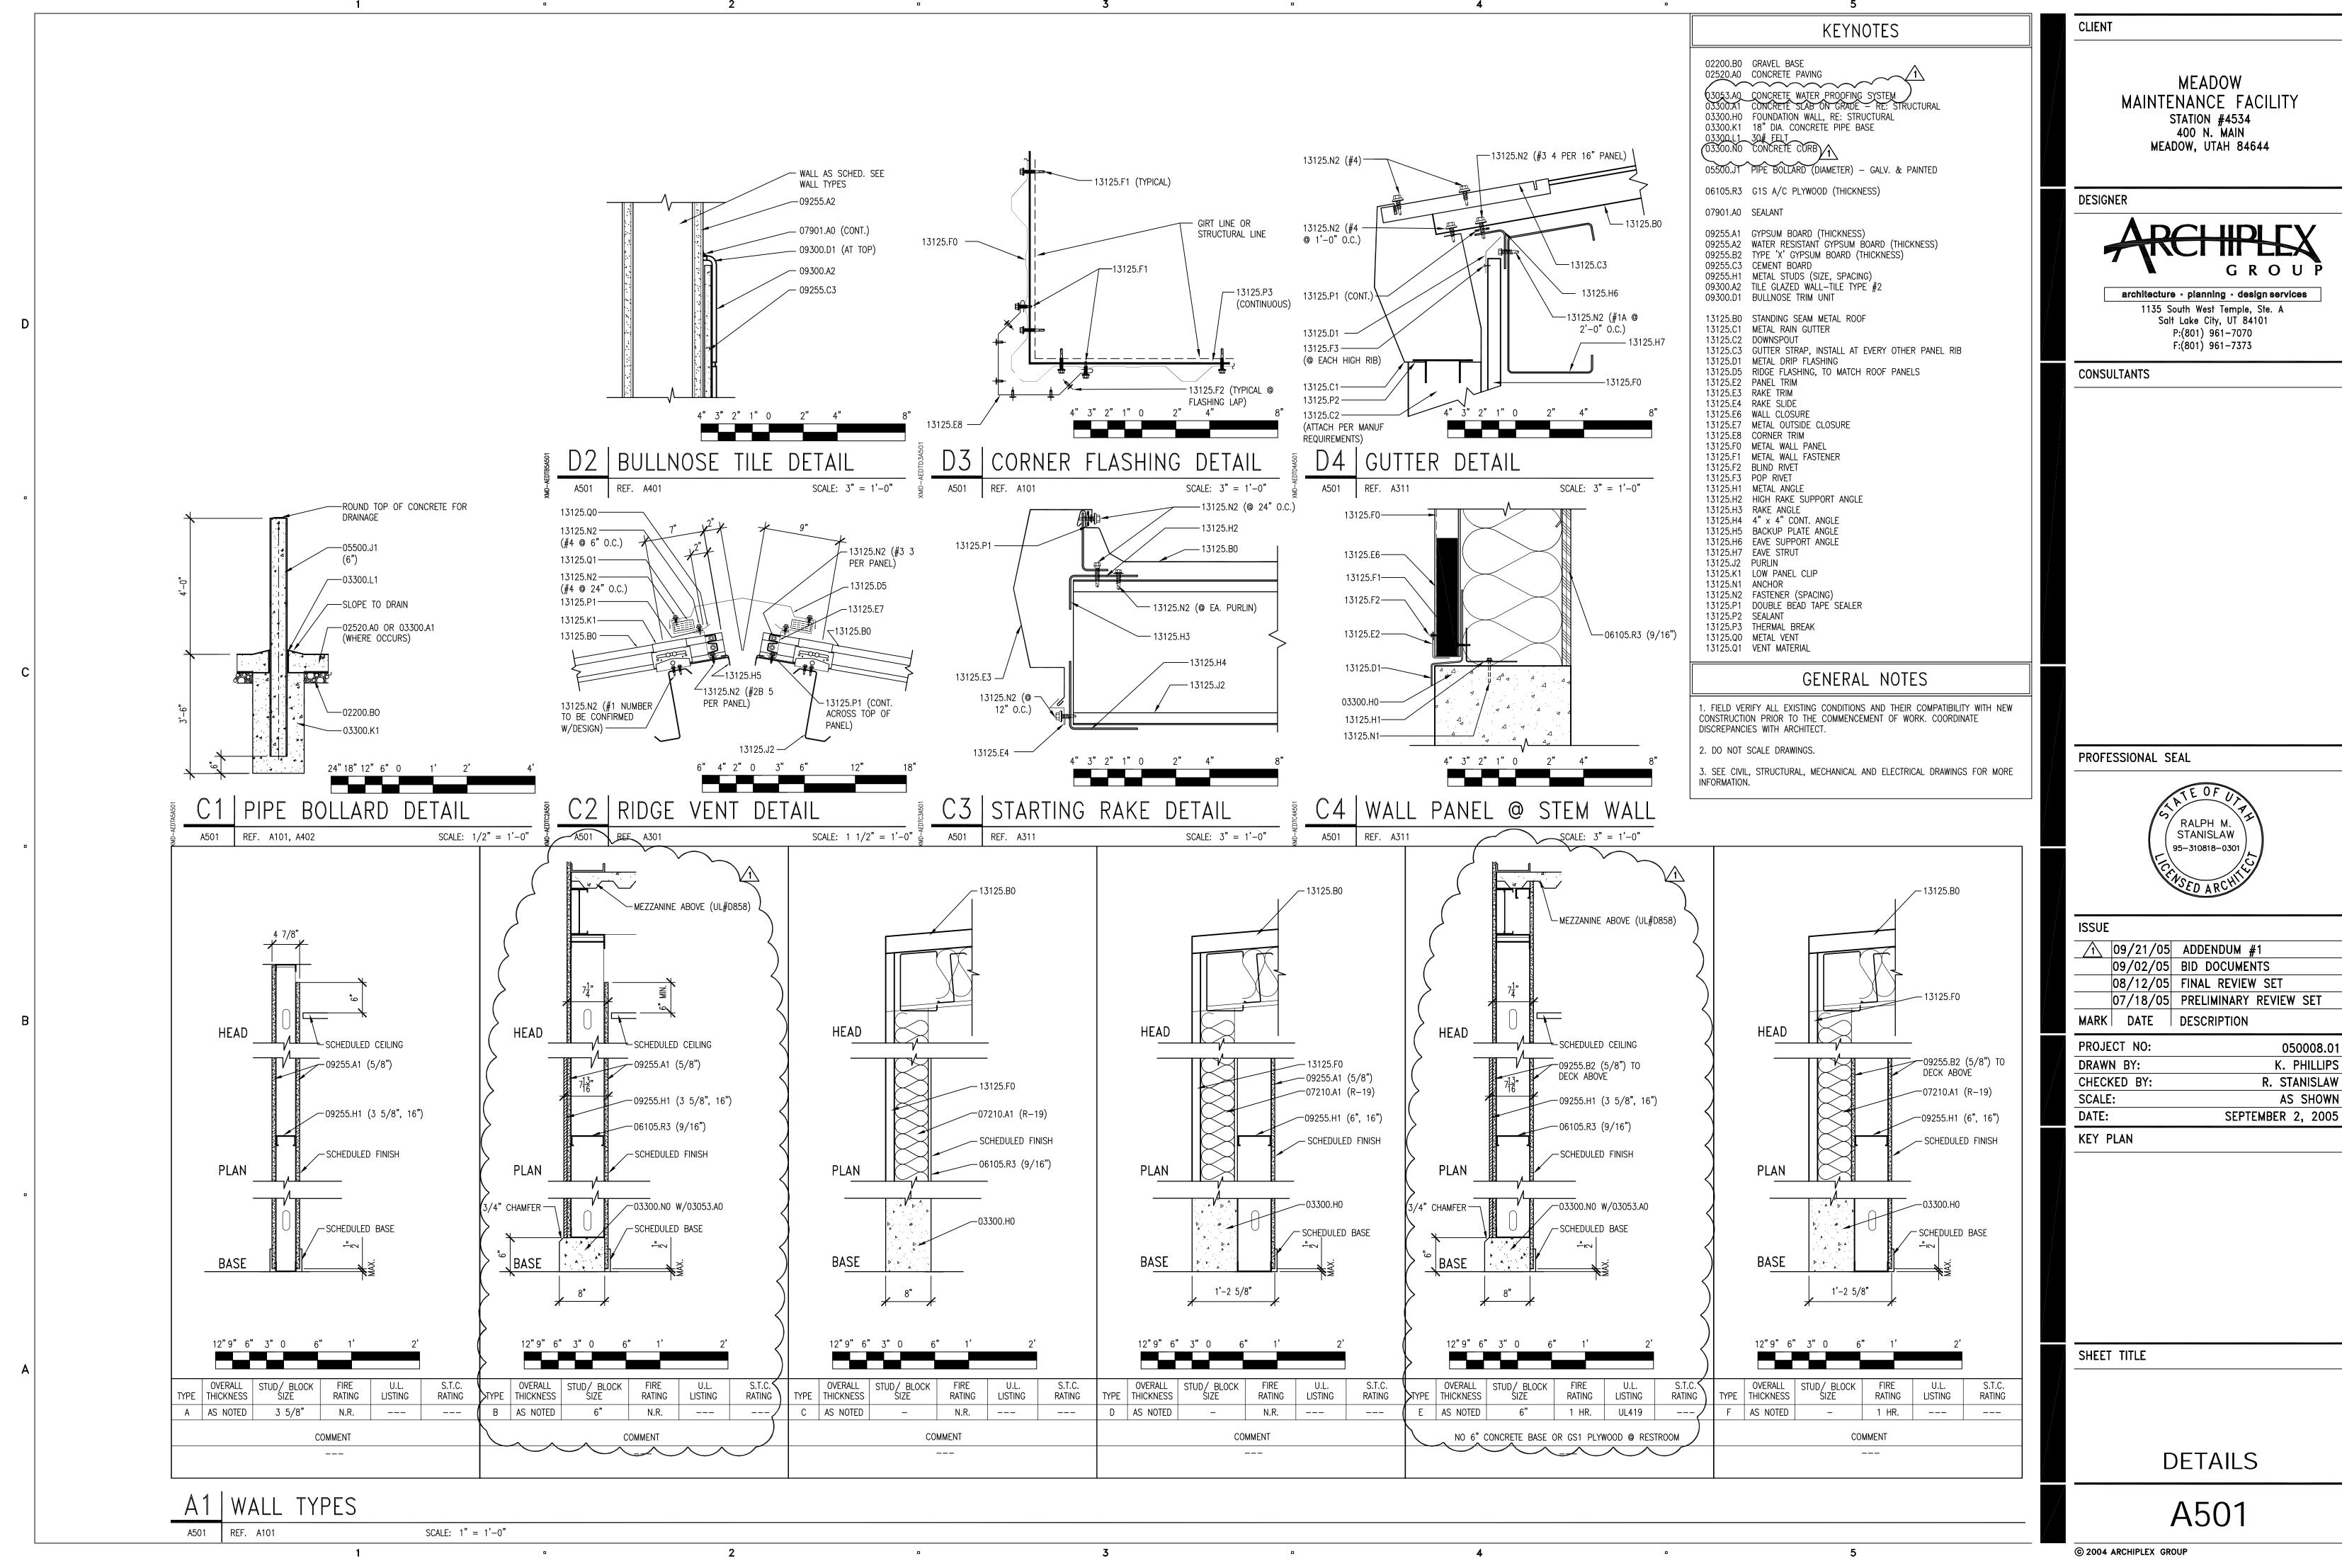




ISSUE	•	
	09/21/05	ADDENDUM #1
	09/02/05	BID DOCUMENTS
	08/12/05	FINAL REVIEW SET
	07/18/05	PRELIMINARY REVIEW SET

1/21/ 51 411	
DATE:	SEPTEMBER 2, 2005
SCALE:	AS SHOWN
CHECKED BY:	R. STANISLAW
DRAWN BY:	K. PHILLIPS
PROJECT NO:	050008.01

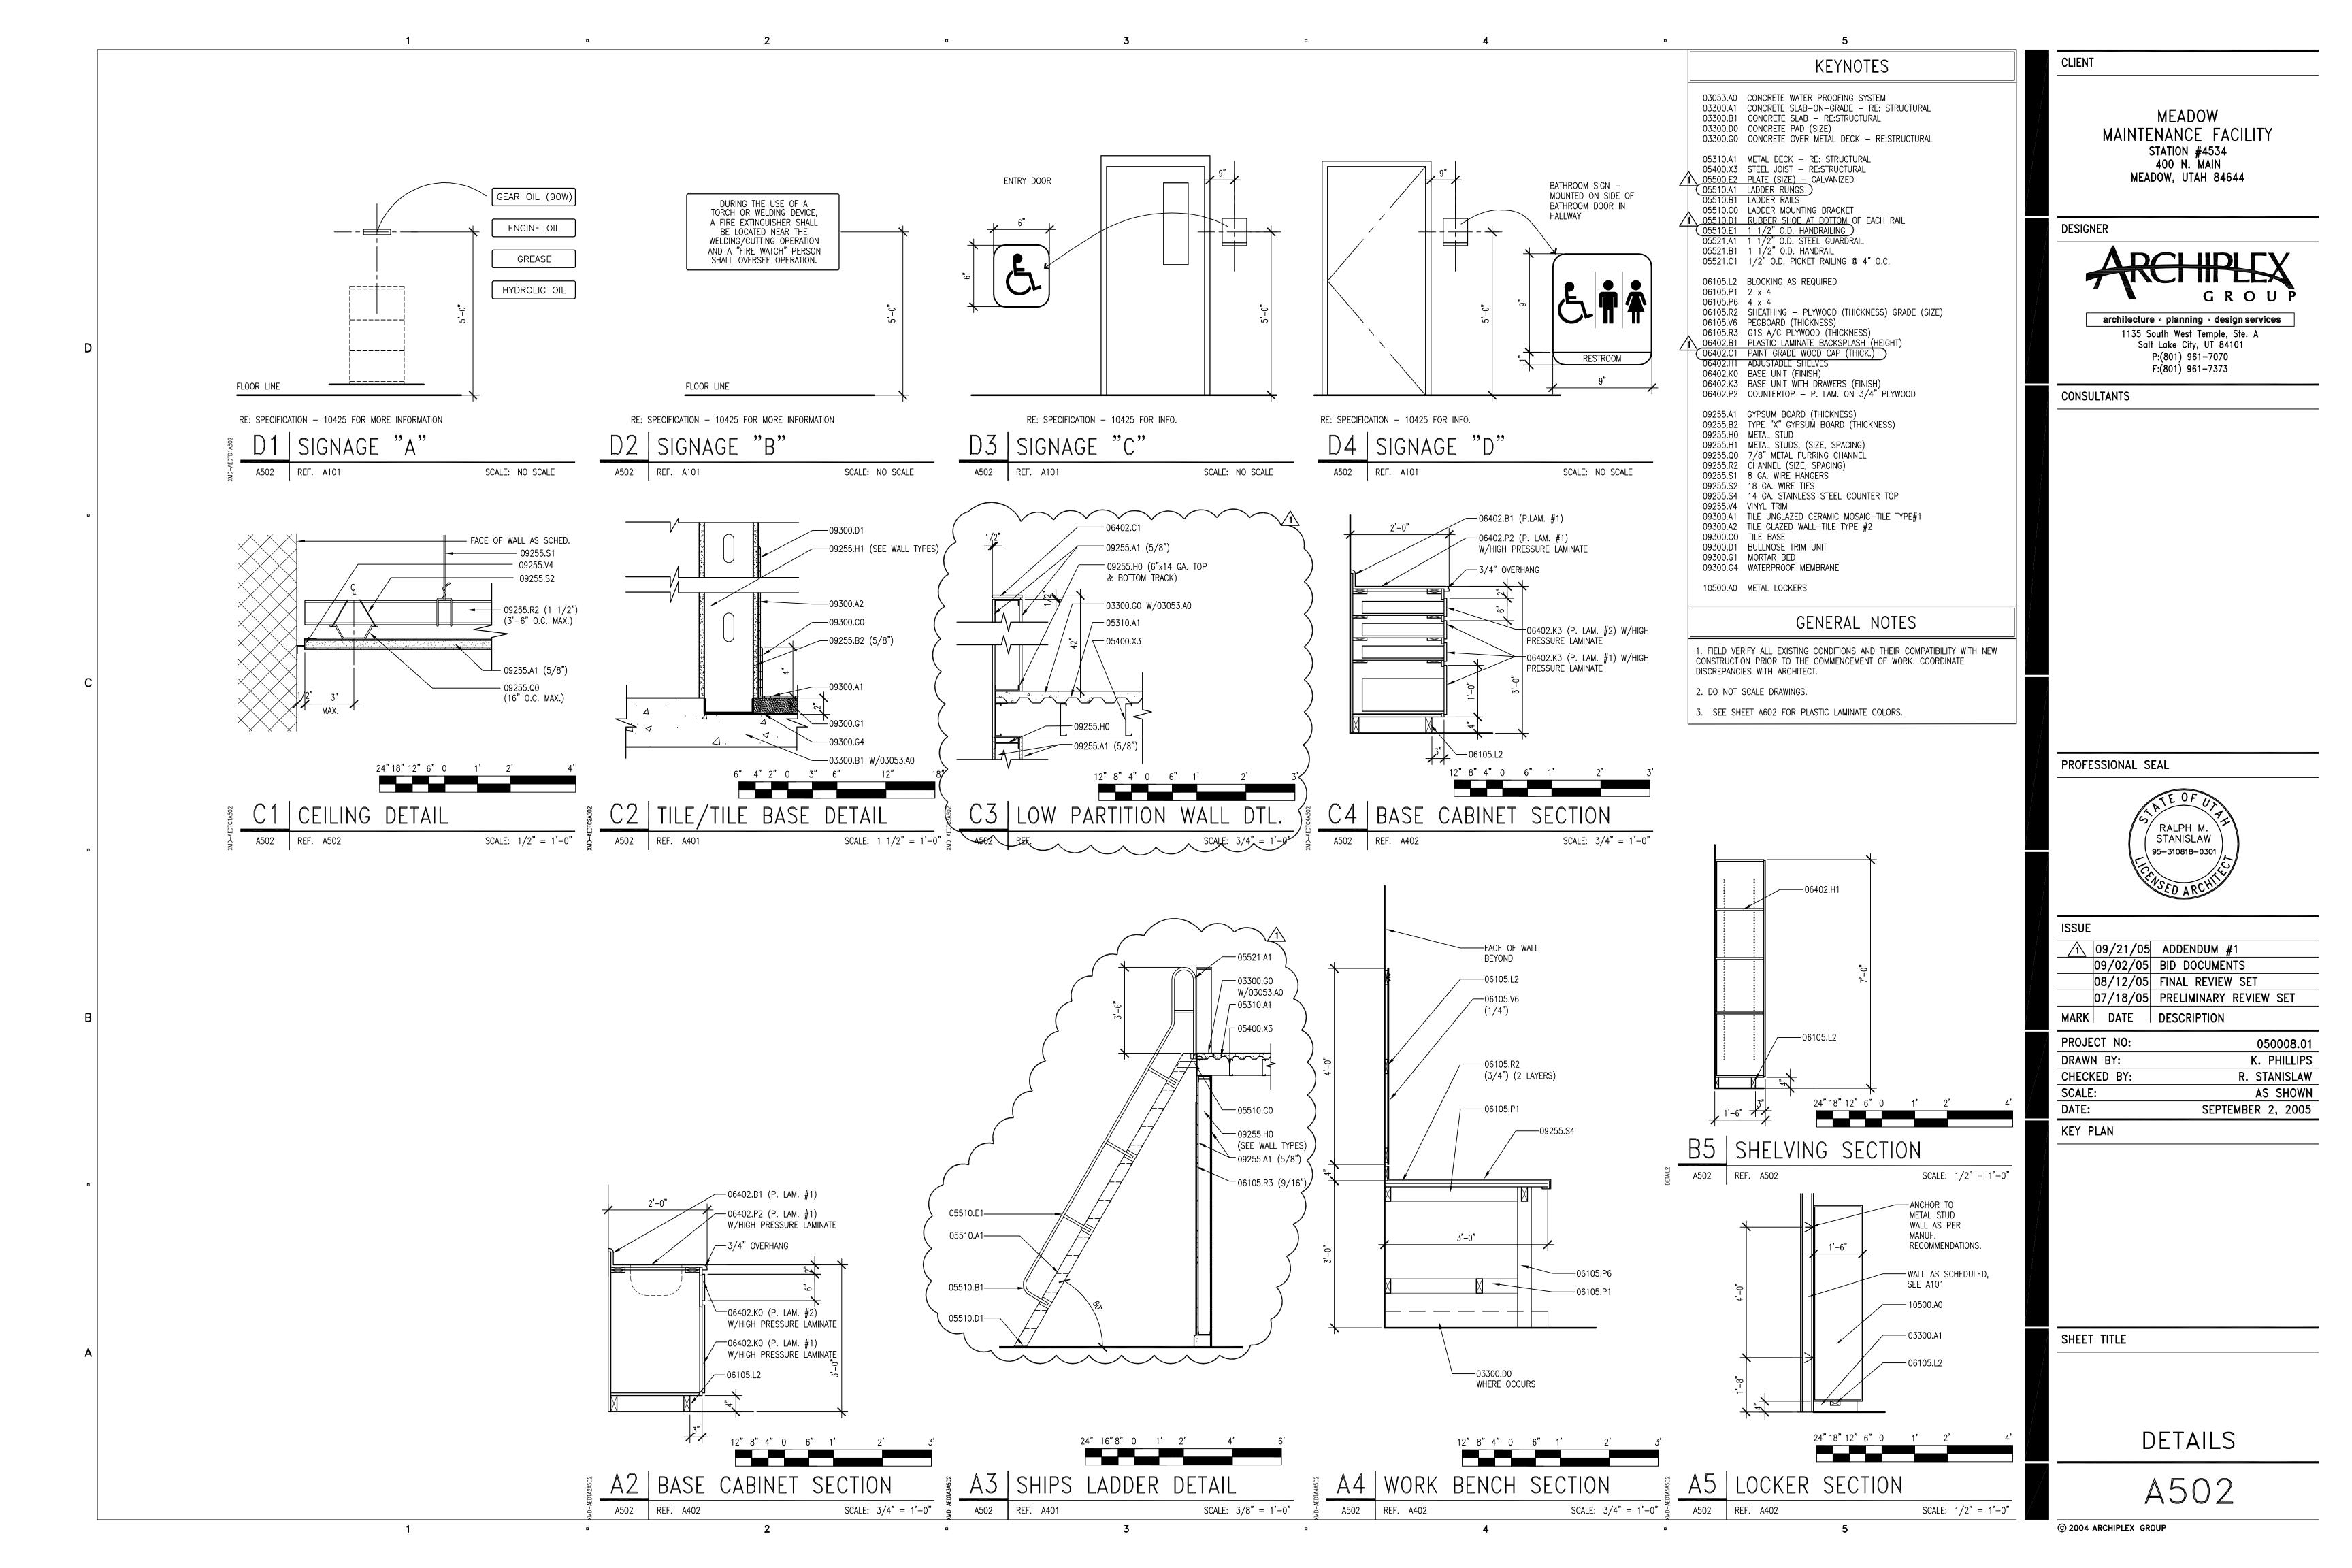

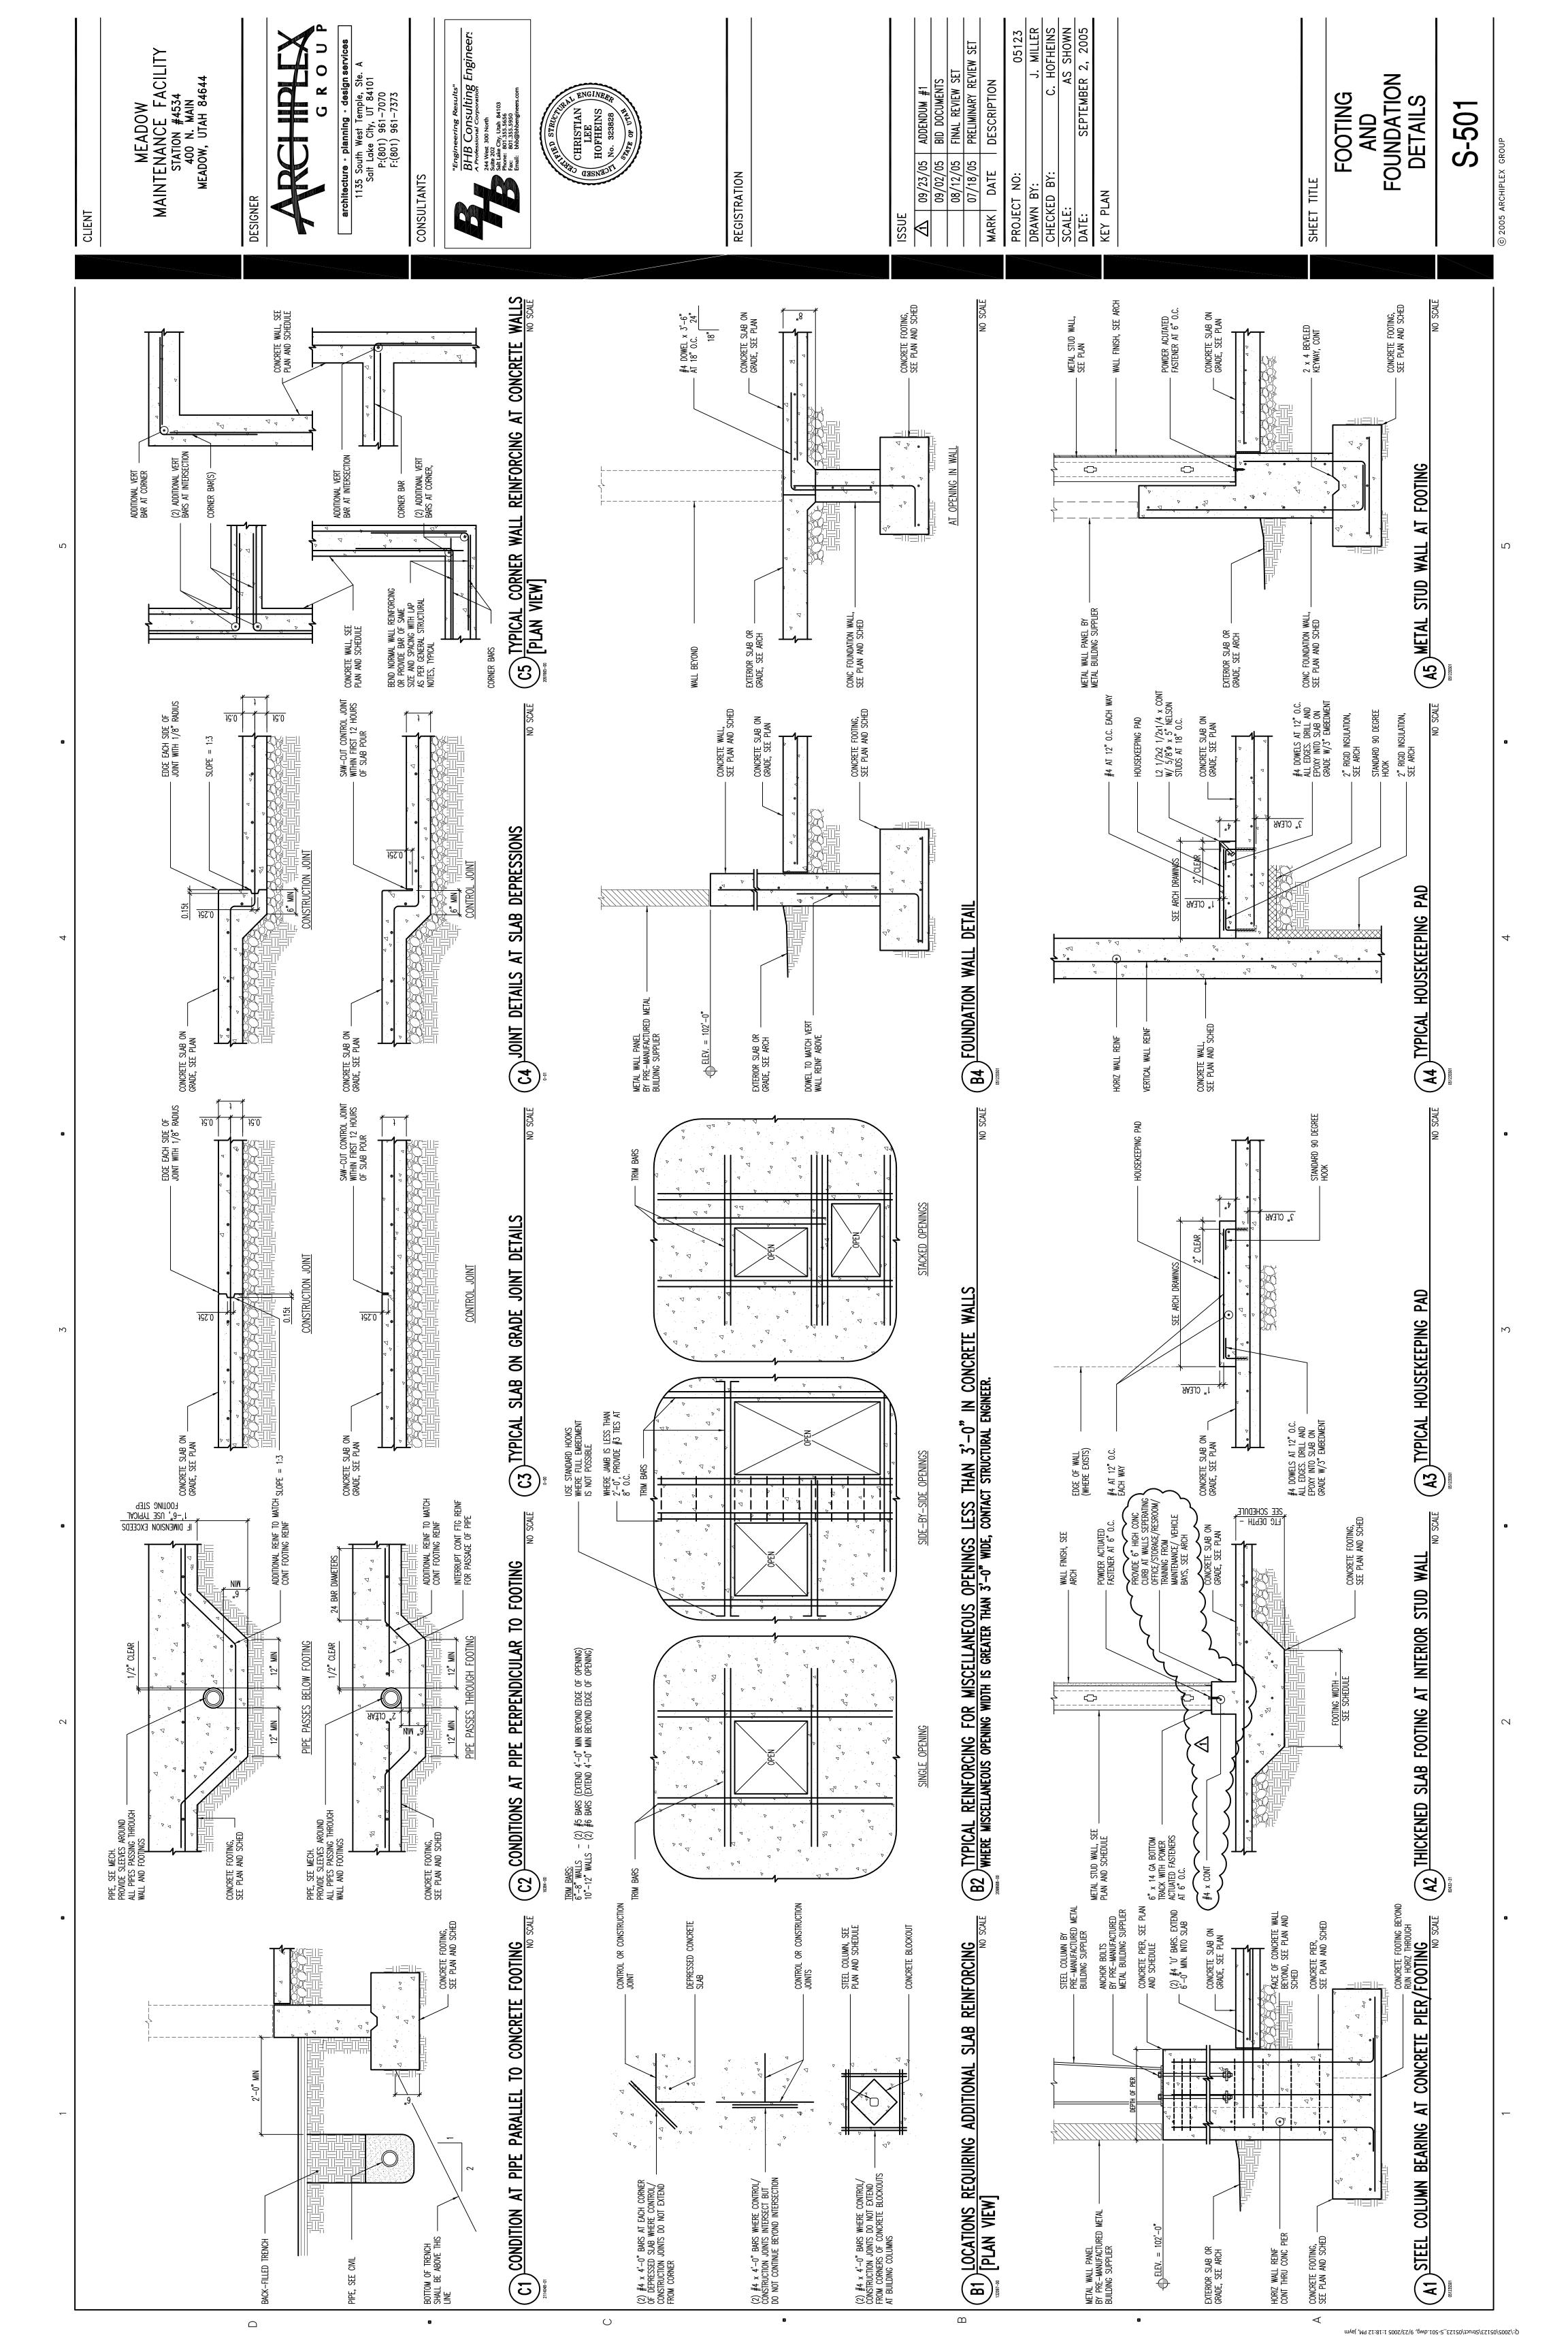

PVE Project No: 04080.02

SCHEDNIE SHEET MECHANICAL SHEET TITLE

100M

© 2004 ARCHIPLEX GROUP

	KEY PLAN
SEPTEMBER 2, 2005	:3TAQ
	2CALE:
.c.d.A	CHECKED BA:
.M.M	DKAWN BY:
0.80008.01	ьколест ио:

DESCRIPTION	MARK DATE
PRELIMINARY REVIEW SET	90/81/20
FINAL REVIEW SET	08/12/02
BID DOCOMENTS	09/02/05
ADDENDUM 1	₩ 09/21/02
	IZZNE

NOT VALID UNLESS SIGNED

Fax: (801) 521-4114

Phone: (801) 359-3158

Consulting Mechanical Engineers

Salt Lake City UT, 84101

90 South 400 West, Suite 340

F:(801) 961-7373

0707-136 (108):9

Salt Lake City, UT 84101

1135 South West Temple, Ste. A

architecture · planning · design services

MEADOW, UTAH 84644 MAM .N 004 4534# NOITATS

MAINTENANCE FACILITY

MEADOW

C K O U P

REGISTRATION

CONSULTANTS

בנ	HOBI CYCLE (4) CONVENIENCE OLITI	42-ITINA (E) 1	INI E	IIOJ aO.	TA909A\	/3 OT 10=	COMME	() 13	JISCONNE	VIDE WITH FILSED I	waa (
	(1) (3) (4) (2) (8) (8)	1/802	01⁄2	23	8.81	97	12	96	ıε	TRANE #2TTB2042A100	ı-na
	BEW∀BK2	VOLTAGE/ PHASE	MOP	MCA	FLA	SUCTION TEMP.	SEER	.AMB.	MBH 2EN	MODEL NO.	ODE
		<u>-n:</u>		HEDN	L 2CI	C NNL	NISN	CONDE	)		

SAFETY INLET SCREEN

A SAFETY INLET SCREEN

(1) PROVIDE INSULATED HOLISING AROLIND MOTOR (2) CONTROL WITH CARRON MONOXIDE DETECTOR THROLIGH ON ALITO SWITCH												)			
080001	COOK #24)	802	09	l	۱-۱/۲	286	,ZG	9.51	G†9	.97.0	0278	NEHICLE SVC BAY	NWOHS SA	EF-2	
999007-	соок #ес	120	09	_	O∂ STTAW	1260	01\8	۲.۱	22	61.0	120	RESTROOM	NWOHS SA	ĒFĪ	
COWWENTS		SITOM	CYCLES CYCLES	Ø	dН	МЧЯ	WALL OPENING ROOF OR		rB,2	JATOT 92	CEM	LOCATION	KEØ,D NO:	SAMBOL	
EXHAUST FAN SCHEDULE															

(1) 15" X 15" FACE MODULE (2) 24" X 24" FACE MODULE (3) 3 CONCENTRIC CONES (4) SET FOR HORIZONTAL DISCHARGE

	MOSIG WINOZIGON GOS 135 (	<u> </u>		1100 2 (2)		// JOVJ "/			311 3013 401 X	
	PRICE #80D	MHITE	.A.N	.A.N	90.0	٥١	DEE SEE	"21 X "21	Transfer Grille	G
	PRICE #80D	WHITE	OBD	029	90.0	٩١	SEE	"21 X "21	КЕТИRN	7
(S) (2) (+)	PRICE #SCDA	WHITE	IN DUCT	9£₽	90.0	17	SEE	ø"Ol	YAW-4 YJ99US	ξ
(S) (F)	PRICE #SCDA	WHITE	IN DUCT	780	90.0	50	SEE PLANS	<b>ø</b> "8	YAW-4 YJ99US	7
(1) (2) (+)	PRICE #SCDA	WHITE	IN DUCT	9/1	90.0	50	SEE	ø <u>"</u> 9	YAW-4 YJ99US	ı
KEWARKS	MANUFACTURER & MODEL NO.	СОГОВ	DAMPER	CFM CFM	dS	N.C. LEVEL MAX	CEILING	SIZE NECK	TYPE & DUTY	PLAN CODE
	EB CEMP E CENTRE	NOMB CBIFF				EDNFE	DE RCH	IK DENI	A	•

(4) HEAT TREATED ALUMIZED STEEL TUBE STAINLESS STEEL REFLECTOR

(1534	ROBERTS GORDON	ø <b>"</b> †	09	ı	120	1.0 RUN	SEE PLANS	35	120,000	NWOHS SA	r-8
COMMENTS	WAKE AND MODEL NUMBER	SIZE LLUE			CONFIG	WEIGHT	TU9NI UT8	LOCATION	SAMBOL		
CAS-FIRED RADIANT HEATERS											

(1) ROBERS CORDON #EP-200 VACUUM PUMP, 3/4HP, 120 VOLT (2) PROVIDE FRESH AIR INTAKE (3) 7-DAY PROGRAMMABLE THERMOSTAT

CONDENSER, EVAPORATOR AND FURNACE BY SAME MANUFACTURER

ENTRIC VENT KIT	30PANE CAS KIT ⑥ CONCI	ld (g)	AOTA!	D EVAPOR	dHt(	00900	OVIDE W/TX(	) PR	R-22 ( <del>4</del>	② NO	)ITAV3J3	TA (S)	Σ6 –	T AFUE
() (9 (G) (C) (D)	TRANE #TUX100C960D	DIRECT	GII	l	09	<b>γ/</b> Σ	~1×~27× <sub>*</sub> +7	l	M9A 0011	<b>č.</b> 0	1400	000'Σ6	100,000	l-∃
COMMENTS	МАИОГРСТОВЕР АИР МОРЕГ ИО.			CACLES MOTC	Ø	dΗ	SIZE ILTER	H NO.	SPEED FAN	.9.2 TX3	CFM	OUTPUT BTU	TUPUT UTB	SAMBOL

	0	0							0	0		0		
(19 (9 (P) (Q) (D)	TRANE #TUX100C960D	DIRECT	SII	l	09	<b>4/</b> Σ	\$Zx.*+2	l	M9A 0011	G.0	1400	000'Σ6	000,001	l-∃
COMMENTS	МАИსFACTURER AND MODEL NO.			CACFE2 WOLC	Ø	ЧΗ	SIZE SIZE	HO.	SPEED FAN	EXT S.P.	CEM	OUTPUT BTU	TUPNI UT8	SAMBOL
			37	CHEDO	)S	√CE	FURN							

(9) CONDENSER, EVAPORATOR AND FURNACE BY SAME MANUFACTURER

TINU NOT 3.5 JANIMON (8)	INSTALLED ACCUMULATOR	√ FACTORY	PRESSURE SWITCH	HICH/FOM E	TATZOI	РВОСВАММАВСЕ ТНЕВМ	9
(4) CONVENIENCE OUTLET	3 ANTI-SHORT CYCLE	OR COIL IN F-1	SCT TO EVAPORATO	⟨∇⟩ CONNE	DISCONNECT	) PROVIDE WITH FUSED	D
						,,,,,,,,,,,,,,,,,,,,,,,,,,,,,,,,,,,,,,,	—

FAN MOTOR 4 CEILING GRILLE 5 COOK WCA-2 WALL CAP AND DAMPER 6 CONTROL WITH MOTION DETECTOR 7 OUTLET LOUVER. SEE NOTE 10 ON DWG. M201 ☐ BRONDE INSULED HOUSING AROUND MOLOR (文 CONTROL WITH CARBON MONOXIDE DELECTOR THROUGH ON/AUTO SWITCH (文) INNER LOCK LOUVER MOTOR WITH

EF-7         PS SHOWN         COCK INCLE SAC BAY         8720         0.12         1.7         8710         1.80         20         1.1         1.0<	0		0	
EE 1 VS CHOMNI BEELBOOM 130 0 1E 32 1 S 8710 0 1E 00 1 30 0 1 S CACTES AOFLS  SAWBOL REG',D  COMMENTS  COMMENTS  COMMENTS  COMMENTS	COOK #2¢XFb (153 \) (88	802 09 1 2/1-1 982	\FHICLE SVC BAY 8720 0.25° 645 13.9 57'	EE-2 VS ZHOMN
SYMBOL 1 100: 1 LOCATION 1 CFM LOTAL 1 SONES 1 WHITE STREET RPS 1	COOK #CC-540 (1) (2) (9)	021 09 1 STTAW 0321	RESTROOM 120 0.15 22 1.7 8/10	EE-1 V2 2HOMN
	COMMENTS	Mda I		
EXHAUST FAN SCHEDULE				

" EVOL NODILE (O) 01" X 04" EVOL NODILE (2) 2 CONCENTED CONCE									*	
	PRICE #80D	MHITE	.А.И	.A.N	90.0	٩١	SEE	12" X 12"	TRANSFER GRILLE	Ç
	PRICE #80D	MHITE	OBD	0Σ9	90.0	٩l	SEE	12" X 12"	КЕТИВИ	<b>†</b>
(S) (4)	PRICE #SCDA	WHITE	IN DUCT	9£ <del>1</del>	90.0	17	SEE	ø"0 l	YAW-4 YJ99US	ξ
(S) (4)	PRICE #SCDA	WHITE	IN DUCT	780	90.0	50	SEE	<b>ø</b> "8	YAW-4 YJ99US	7
(1) (3) (4)	PRICE #SCDA	WHITE	IN DUCT	921	30.0	50	SEE PLANS	<b>ø</b> "9	YAW-4 YJ99US	l
BEWARKS	MANUFACTURER & MODEL NO.	СОГОВ	DAMPER	CFM MAX.	dS	N.C. LEVEL MAX	LYPE	SIZE NECK	TYPE & DUTY	CODE PLAN
		EDNFE	DE 2CH	IK DENI	A					

(15) ALL RETURN AIR GRILLES SHALL HAVE SOUND BOOTS W/ LINED INSULATION. INSULATION IS TO BE PAINTED FLAT

(16) DIVISION 15 TO SUBMIT TO ENGINEER ALL AS-BUILTS OF BUILDINGS MECHANCIAL AND PLUMBING SYSTEMS PRIOR

(14) HOUSEKEEPING PADS FOR ALL EQUIPMENT IS PROVIDED AND INSTALLED BY GENERAL CONTRACTOR. COORDINATE (13) EACH TRADE IS RESPONSIBLE THEIR OWN FIRE CAULKING.

AND THE CURRENT ADOPTED EDITION OF NFPA AND BUILDING CODE.

(12) FIRE SPRINKLER CONTRACTOR SHALL DESIGN AND INSTALL FIRE PROTECTION SYSTEM PER REFLECTED CEILING PLAN (1) DUCT DIMENSIONS SHOWN ARE INSIDE CLEAR DIMENSIONS.

SHALL MAKE CHANGES WITHOUT ADDITIONAL COSTS.

TO JOB COMPLETION AND FINAL PAYMENT.

(10) ALL DIFFUSERS MUST BE BALANCED TO THE VALUES INDICATED ON THE FLOOR PLANS. PROVIDE BALANCE REPORT TO ENGINEER PRIOR TO PROJECT CLOSEOUT.

9 THIS CONTRACTOR SHALL PROVIDE SUBMITTALS ON ITEMS LISTED IN MECHANICAL EQUIPMENT LIST TO THE ENGINEER FOR REVIEW PRIOR TO THE ORDER, PURCHASE OR INSTALLATION.

BUILDING CODES, FIRE CODES, MECHANICAL CODES AND PLUMBING CODES. 8 ALL MECHANICAL SYSTEMS SHALL BE INSTALLED IN ACCORDANCE WITH THE CURRENT ADOPTED EDITION OF THE

(UNLESS OTHERWISE NOTED ON FLOOR PLANS) SHALL BE CONSTRUCTED OF 1" W.C. SEAL CLASS "B". THIS CONTRACTOR SHALL USE SMACNA DUCT CONSTRUCTION STANDARDS FOR SHEET METAL DUCTS. ALL DUCTWORK

WILL NOT BE ALLOWED FOR CONTRACTOR'S FAILURE TO BECOME FAMILIAR WITH SITE CONDITIONS. 6 THIS CONTRACTOR SHALL FIELD VERIFY ALL MECHANICAL ITEMS PRIOR TO STARTING NEW WORK. ADDITIONAL COST

BUILDING STRUCTURE.

5 THIS CONTRACTOR SHALL CLOSELY COORDINATE NEW MECHANICAL WITH NEW ELECTRICAL, ARCHITECTURAL AND

ALTERNATE ROUTING, OFFSETS AND TRANSITIONS ARE REQUIRED FOR COORDINATION OF WORK, THIS CONTRACTOR (4) DUCTWORK AND PIPE ROUTING AS SHOWN ON DRAWINGS IS DIACRAMMATIC AND IS NOT TO BE SCALED. WHERE

 $\mathfrak{Z}$  ALL DUCTWORK IS TO BE LINED OR WRAPPED IF ROUND. NO DUCTBOARD IS ALLOWED.

MAXIMUM OF 6 FT. LONG. ALL INSULATION TO MEET NFPA 90 PER UL 181-CLASS 1. NO DUCTBOARD ALLOWED. AND TRIM AND SEAL JOINTS. LOW PRESSURE ROUND FLEXIBLE DUCT TO BE  $1-rac{1}{2}$ " THICK INSULATED AND A 2 ALL DUCTWORK SHALL RECEIVE 1" - 1.5 LBS/CU.FT. DUCT LINER, ATTACH TO DUCT WITH MECHANICAL FASTENERS

(1) COORDINATE ALL FIRE SPRINKLER HEADS AND AIR DEVICE LOCATIONS WITH REFLECTED CEILING PLANS AND

CENERAL NOTES:

SECTION NO. SECTION CUT LINE KELED NOTE DETAIL TAG DETAIL NO. —— POINT OF CONNECTION TO EXISTING THERMOSTAT OR TEMP SEUSOR COMBINATION FIRE/SMOKE DAMPER FIRE DAMPER MOTORIZED DAMPER MANUAL VOLUME DAMPER ACCESS PANEL CEILING GRILLE CEILING EXHAUST GRILLE CEILING DIFFUSER CEILING SLOT DIFFUSER FLEXIBLE DUCT SPIN-IN FITTING W/MVD SUPPLY AIR DUCT UP имод тэид яід үлддиг

CONTROL TRANSFORMER

(XAT)


(NOT ALL USED) MECHANICAL LEGEND

RETURN OR EXHAUST DUCT UP

RETURN OR EXHAUST DUCT DOWN

CLIENT

DEZIGNEK

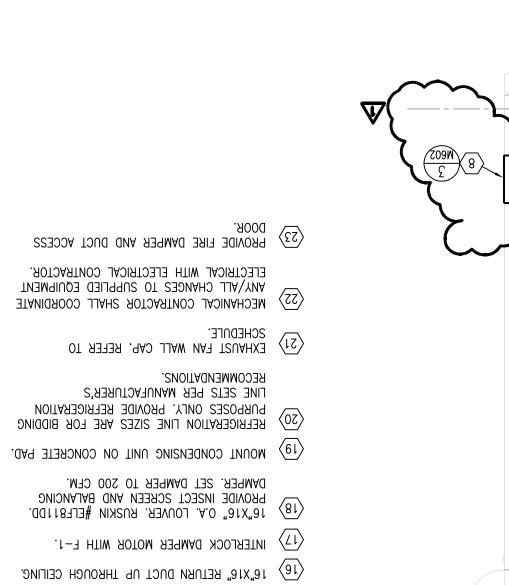

(15) 16"X16" RETURN DOWN THROUGH FLOOR.

(13) 18"X12" DUCT UP THROUGH CEILING.

LOUVER COLOR BY ARCHITECT.

 $\langle \, 9 \, 
angle$  REFERENCE ARCH. DRAWINGS FOR LOCATION.

ARCHITECTURAL DRAWINGS FOR LOCATION. INTERLOCK ACTUATOR WITH EF-2. REFER TO

(8) 62"x62" COMBINATION LOUVER, ALUMINUM RUSKIN ELC445D, PROVIDE WITH ACTUATOR.

 $\langle 5 \rangle$  Radiant Heat system control panel.

(4) 4" TYPE B FLUE THROUGH ROOF. INSTALL PER MANUFACTURERS RECOMENDATIONS.

3
ight
angle mount radiant heaters parallel with roll up doors. (Typical)

KELED NOTES:

 $\langle 2 \rangle$  4" COMBUSTION THROUGH ROOF.

THROUGH AUTO/ON SWITCH WITH EXHAUST  $\langle \gamma \rangle$  Carbon monoxide detector. Interlock

12 THERMOSTAT TO CONTROL F-1.

(14) NOT USED.

 $\langle 6 \rangle$  MOUNT 5'-0" AFF.

(1) NOT USED.

MARK | DATE | DESCRIPTION

√ 09/21/02 | ADDENDUM 1


Fax: (801) 521-4114 Phone: (801) 359-3158

Consulting Mechanical Engineer

F:(801) 961-7373 0707-136 (108):9 1135 South West Temple, Ste. A Salt Lake City, UT 84101 architecture · planning · design services

C K O N P

MEADOW, UTAH 84644 MIAM .N 004 4224# NOITATS MAINTENANCE FACILITY **MEADOW** 

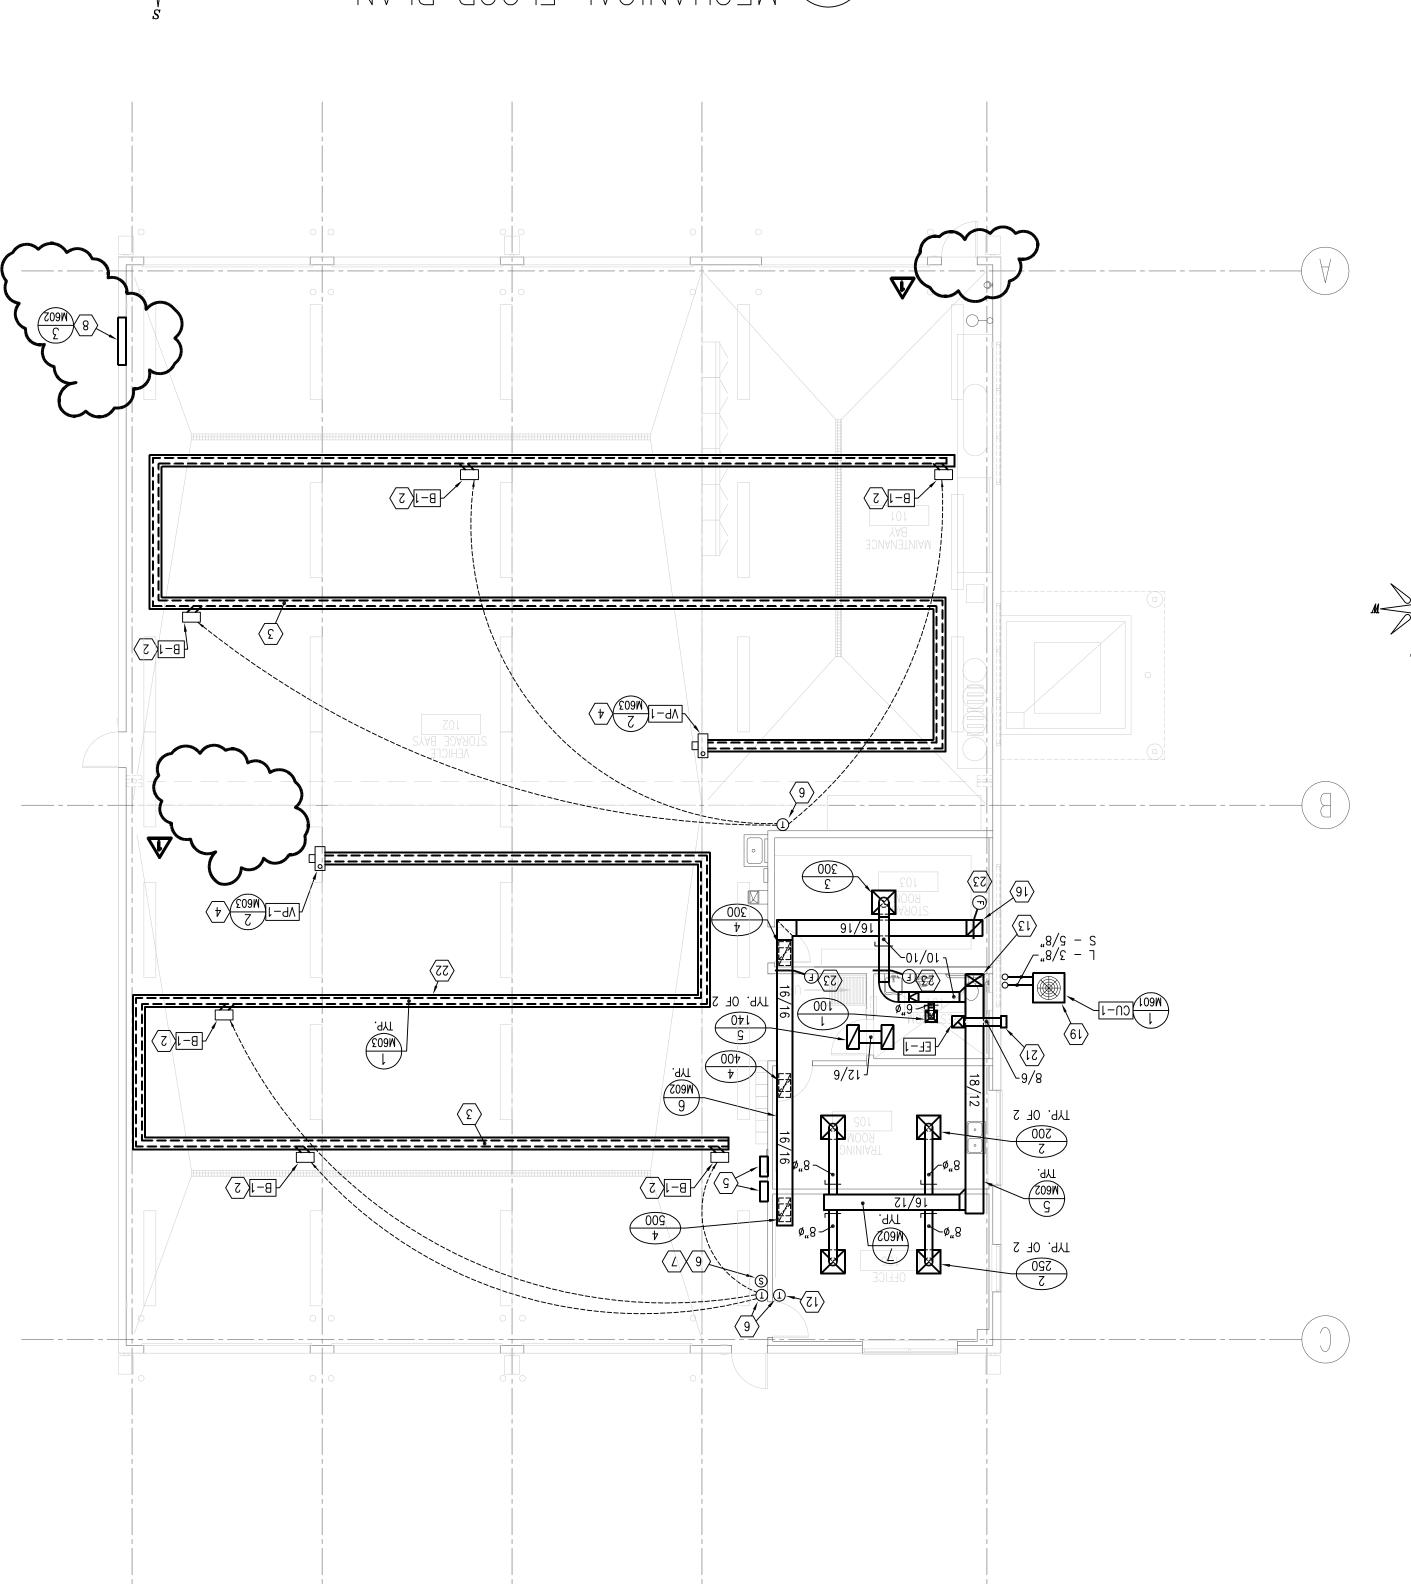

NOT VALID UNLESS SIGNED ALAN D. 166911

07/18/05 PRELIMINARY REVIEW SET

08/12/05 FINAL REVIEW SET 09/02/05 BID DOCUMENTS

SEPTEMBER 2, 2005

.S.G.A

.M.M

10.800020

REGISTRATION

KEX FLAN

CHECKED BA:

PROJECT NO:

DRAWN BY:

:3TAQ

2CALE:


IZZNE

Salt Lake City UT, 84101 90 South 400 West, Suite 340

CONSULTANTS

DEZIGNEK

CLIENT

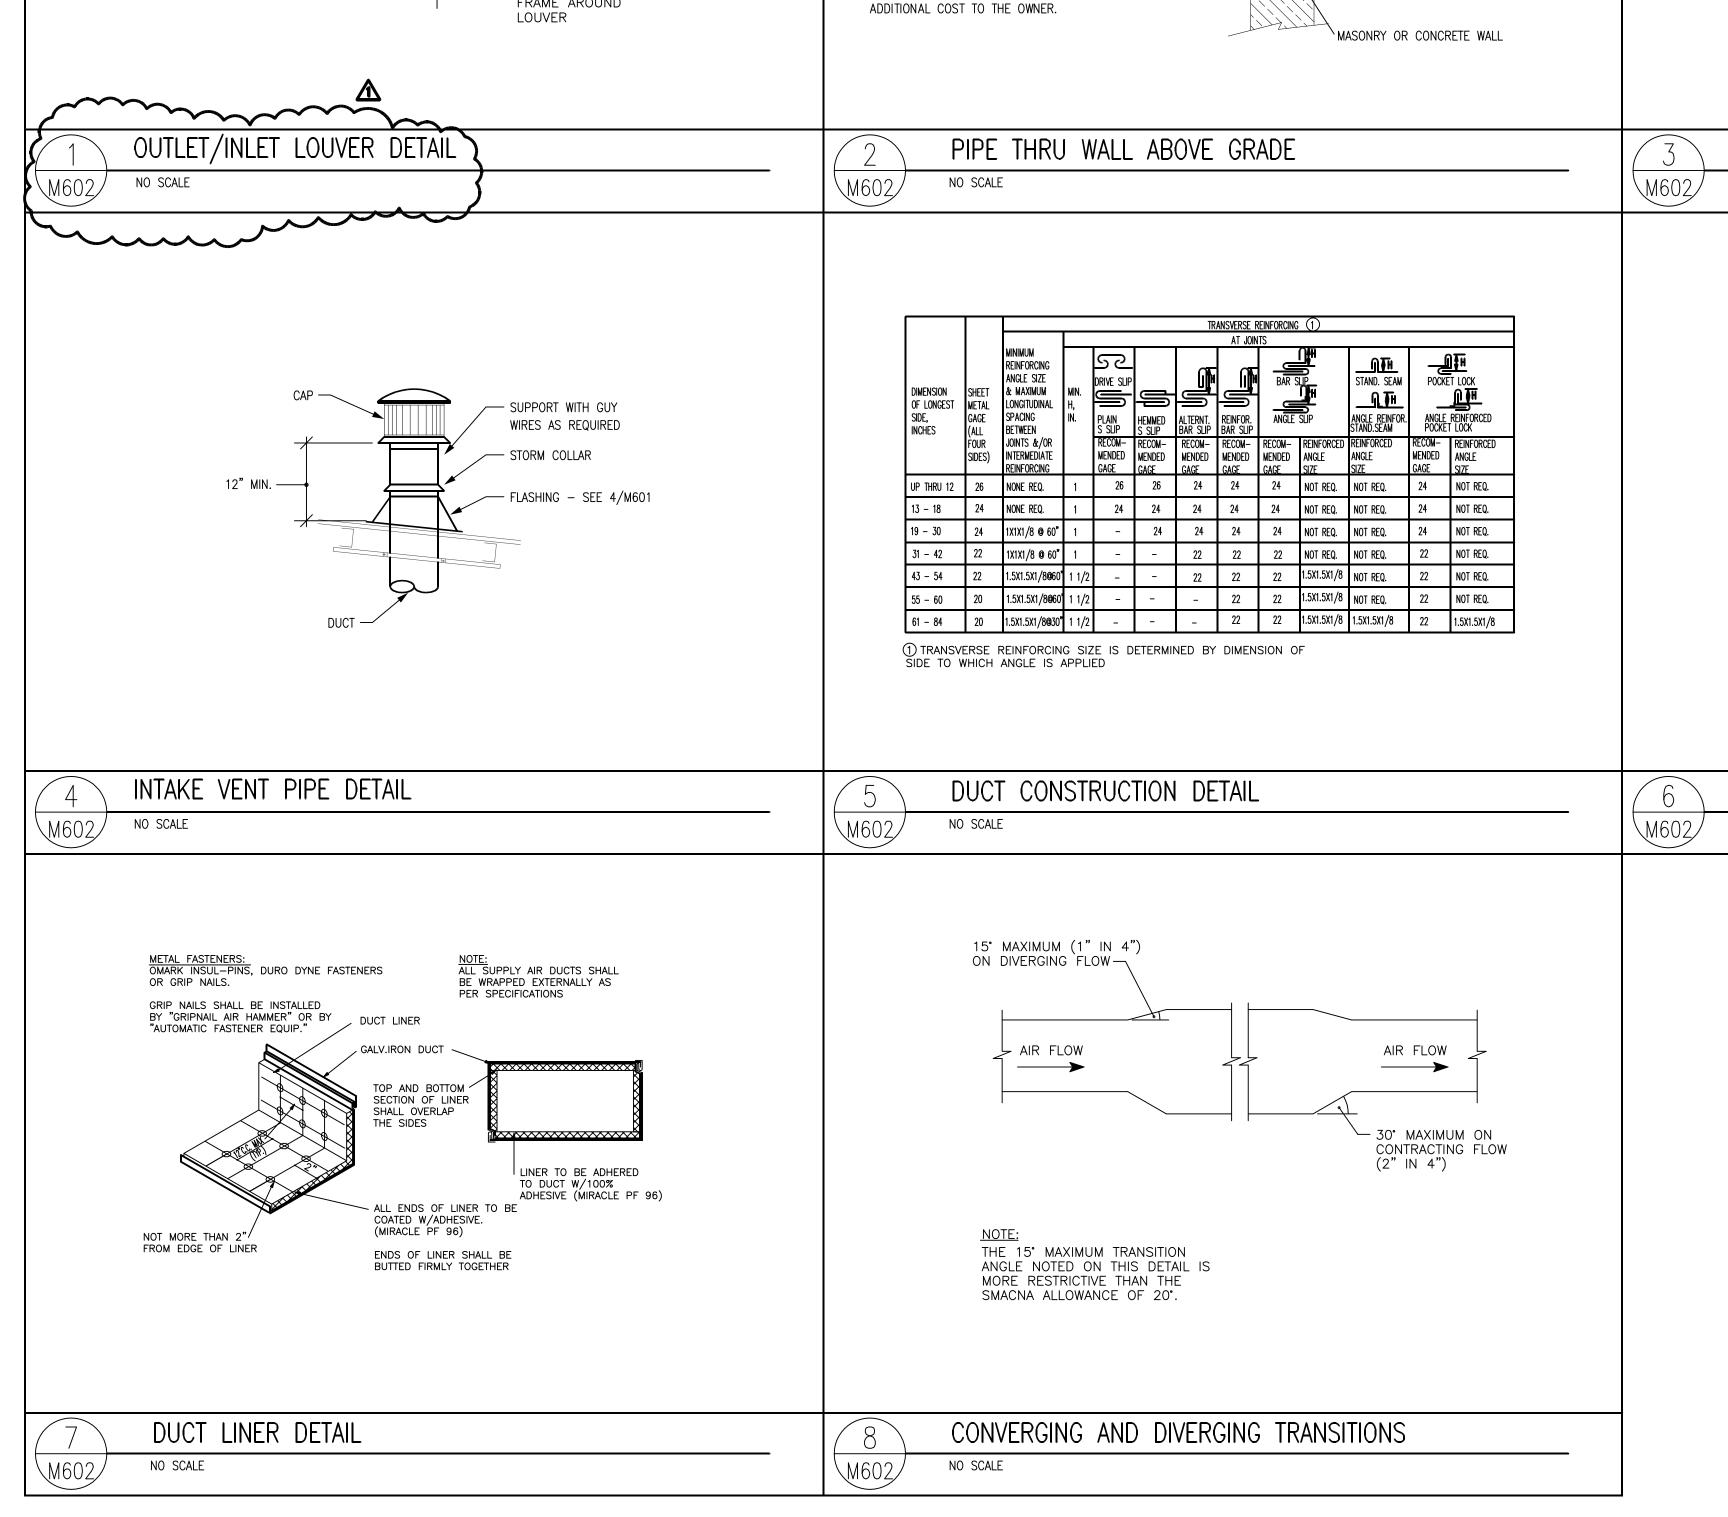

– ALUMINUM OR STAINLESS STEEL BIRD

INLET LOUVER

REMOVABLE SERVICE

ELECTRIC MOTOR

6"x2" CHANNEL

FRAME AROUND

SCREEN

SCREEN

ACTUATOR

PROVIDE SEALANT -ALL AROUND (TYP.)

METAL BUILDING -

⚠ | 09/21/05 | ADDENDUM 1 09/02/05 BID DOCUMENTS 08/12/05 FINAL REVIEW SET 07/18/05 PRELIMINARY REVIEW SET


PROJECT NO: 050008.01 DRAWN BY: M.M. CHECKED BY: A.D.S. SCALE: DATE: SEPTEMBER 2, 2005

SHEET TITLE

PVE Project No: 04080.02

MECHANICAL **DETAIL SHEET** 

M602

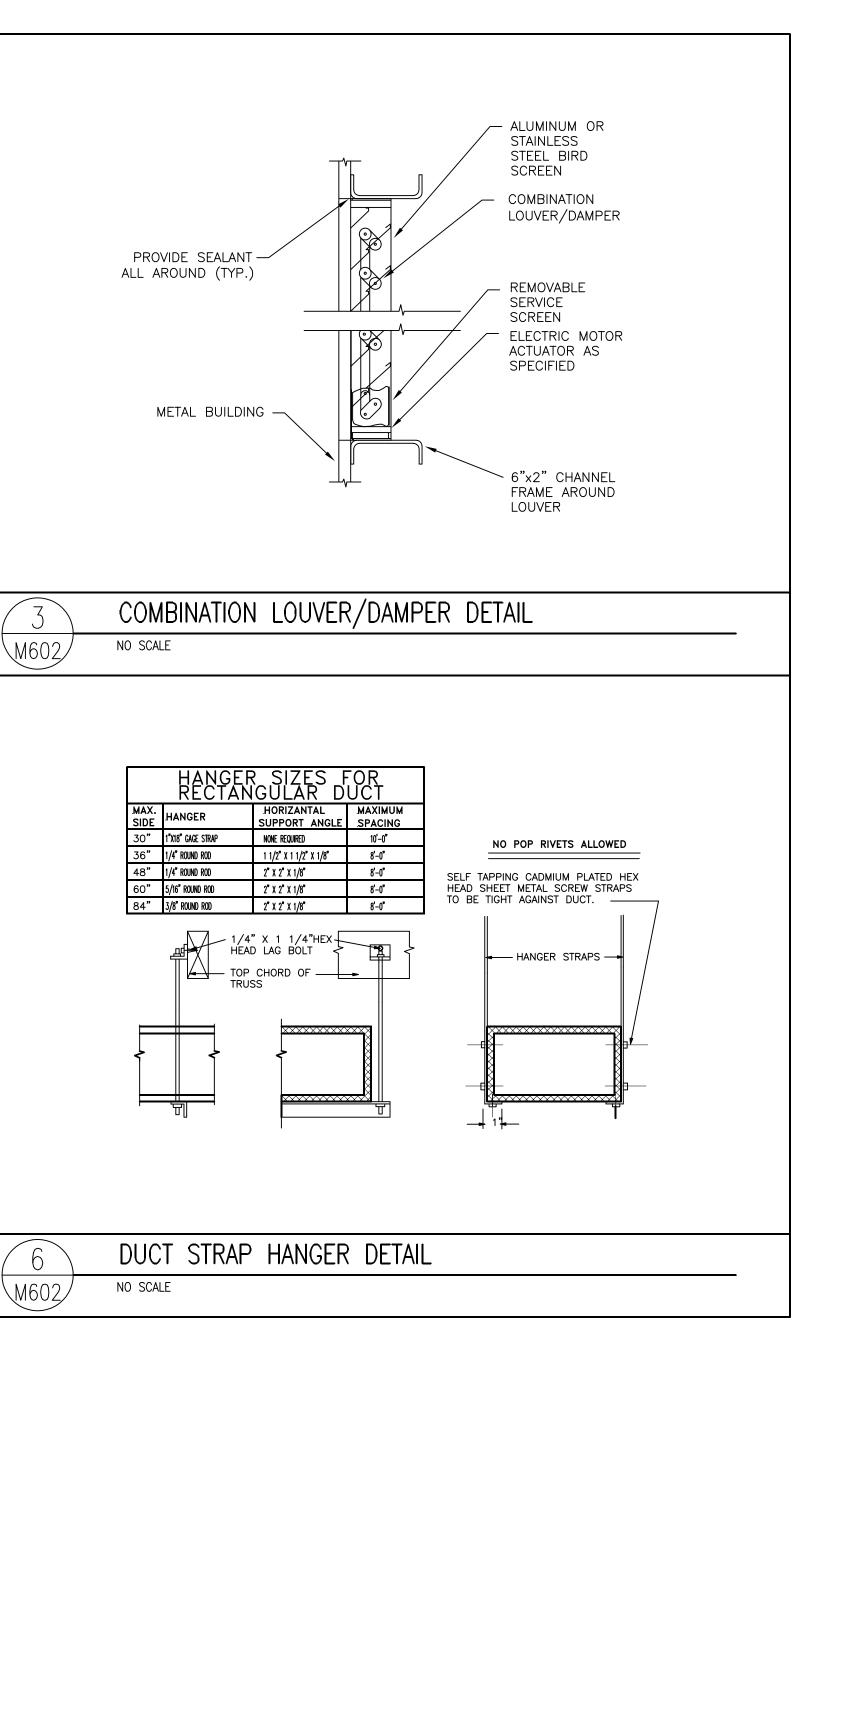

ESCUTCHEON WHERE PIPE IS EXPOSED IN FINISHED SPACE.

NOT REQUIRED WHERE SLEEVE

- PROVIDE 1/4" MIN. CLEAR

AROUND BARE PIPE OR INSULATED PIPE.

IS ABOVE CEILING.

METAL PIPE SLEEVE

PIPE —

WHERE PIPING IS EXPOSED TO EXTERIOR, PROVIDE SEALANT & BACK-UP

PIPE SLEEVES ARE REQUIRED ON THIS PROJECT. CONTRACTOR

SHALL BE REQUIRED TO REMOVE ANY PIPE INSTALLED WITHOUT A PIPE SLEEVE, INSTALL THE SLEEVE

AND REINSTALL THE PIPE AT NO

MATERIAL.

MEADOW, UTAH 84644

CLIENT

ADCLUDI TY GROU

MEADOW

MAINTENANCE FACILITY STATION #4534 400 N. MAIN

architecture • planning • design services 1135 South West Temple, Ste. A Salt Lake City, UT 84101 P:(801) 961-7070 F:(801) 961-7373


CONSULTANTS

DESIGNER



90 South 400 West, Suite 340 Salt Lake City UT, 84101 Phone: (801) 359-3158 Fax: (801) 521-4114

REGISTRATION

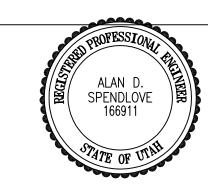

NOT VALID UNLESS SIGNED

ISSUE

MARK DATE DESCRIPTION

KEY PLAN

SHEET TITLE

KEY PLAN SEPTEMBER 2, 2005 :3TAQ SCALE: .S.G.A CHECKED BA: .M.M DRAWN BY: 10.800020 PROJECT NO:

MARK | DATE | DESCRIPTION 07/18/05 PRELIMINARY REVIEW SET 08/12/05 FINAL REVIEW SET 09/02/05 BID DOCUMENTS 

NOT VALID UNLESS SIGNED



REGISTRATION

Fax: (801) 521-4114 Phone: (801) 359-3158 Salt Lake City UT, 84101 90 South 400 West, Suite 340 Consulting Mechanical Engineer

CONSULTANTS

F:(801) 961-7373 0707-136 (108):9 1135 South West Temple, Ste. A Salt Lake City, UT 84101 architecture · planning · design services

G R O U P

DEZIGNEK

MEADOW, UTAH 84644 MIAM .N 004 4534# NOITATS MAINTENANCE FACILITY **MEADOW** 

501 SCALE:1/8" = 1' - 0" 6' 0 4' 8' 12' 16'

AT NO ADDITIONAL EXPENSE TO THE OWNER. PIPE, INŚTALL SLEEVE AND REINSTALL PIPE SLEEVES, THE CONTRACTOR SHALL REMOVE PIPE SLEEVES REQUIRED ON THIS PROJECT.

IF CONTRACTOR FAILS TO INSTALL PIPE (16) NATURAL GAS LINE DOWN TO BURNER.
PROVIDE SHUT-OFF VALVE, UNION AND
APPLIANCE REGULATOR REFERENCE DETAIL 1– $\mbox{\ensuremath{\mbox{\ensuremath{\mbox{\sc M}}}}\mbox{\ensuremath{\mbox{\sc M}}}\mbox{\ensuremath{\mbox{\sc M}}}\mbox{\$ (15) AIR COMPRESSOR BY CONTRACTOR. CONNECT CONTRACTOR. BARRELS. PROVIDE SHUT-OFF VALVE. LUBE (14) DROP 1" COMPRESSED AIR LINE TO LUBE DROP  $\S_{*}$  COMPRESSED AIR DOWN TO OIL DRAIN PUMP. PROVIDE SHUT-OFF VALVE. TO DETAIL 5/P601. VERIFY MOUNTING HEIGHT WITH OWNER. REFER DISCONNECT. PROVIDE SHUT-OFF VALVE. SHUT-OFF AND UNION. HOSE REEL BY CONTRACTOR. CW LINE TO OVERHEAD HOSE REEL. PROVIDE CONNECT 1" COMPRESSED AIR LINE AND ¾" VERIFY LOCATION. CONNECT OIL DRAIN LINE TO DRAIN PUMP.
RUN DRAIN LINE OUT TO CATCH TANK.
PROVIDE SHUT—OFF VALVE AND UNION. CATCH
TANK FURNISHED BY OWNER, INSTALLED BY
CONTRACTOR. DRAIN PUMP BY CONTRACTOR. 2 PSI TO 4 OZ. BTU/CFH. PROVIDE APPLIANCE REGULATOR AT SPECIFIC GRAVITY AND HEAT CONTENT OF 840 (9) 1012 CFH OF 2 PSI NATURAL GAS WITH 0.60 (8) CAP LINE FOR FUTURE EXPANSION.  $\langle \gamma \rangle$  NOT USED. SLOPE 🔏" PER F00T.  $\langle 6 \rangle$  ALL WASTE PIPING 3" AND GREATER TO (5) ROUTE PIPING ABOVE STRUCTURE. 4 PROVIDE PVC COVER OVER INSULATION TO 8'-0" AFF. RIM OF SEPARATOR AND THEN CONNECTED TO VEHICLE STORAGE BAY WASTE SYSTEM VENT COMBINED AFTER THEY ARE 10' ABOVE FLOOD 3 Vents from Sand/Oil Separator may be CORRECTLY TO CODE STANDARDS. THAT THE SAUITARY PIPE CAN BE INSTALLED SHALL PERFORM ANY WORK REQUIRED SUCH ARISES, THE CONTRACTOR, AT HIS EXPENSE,


PIPE. IF PIPE IS INSTALLED AND A PROBLEM OF THE PROBLEM PRIOR TO INSTALLING ANY CONTRACTOR IS TO INFORM THE ARCHITECT OR BUILDING. IF A PROBLEM EXISTS, THE INSTALLING ANY SANITARY PIPE IN THE SITE WILL PROPERLY CONNECT PRIOR TO SEMER AND BUILDING SANITARY SEWER PIPE WITH HIS SUBS TO VERIFY SITE SAUITARY CENERAL CONTRACTOR IS TO COORDINATE CEVATION.

1 SEE SITE DRAWINGS FOR CONTINUATION.

KELED NOLES:

HB-J(¢) HB-J(¢) √ES-1 1 X 9) NATURAL GAS 6 099 . TYT (1) 2" DOMESTIC WATER |-*"*2/1-1 HB-J (†) I-HM

CLIENT

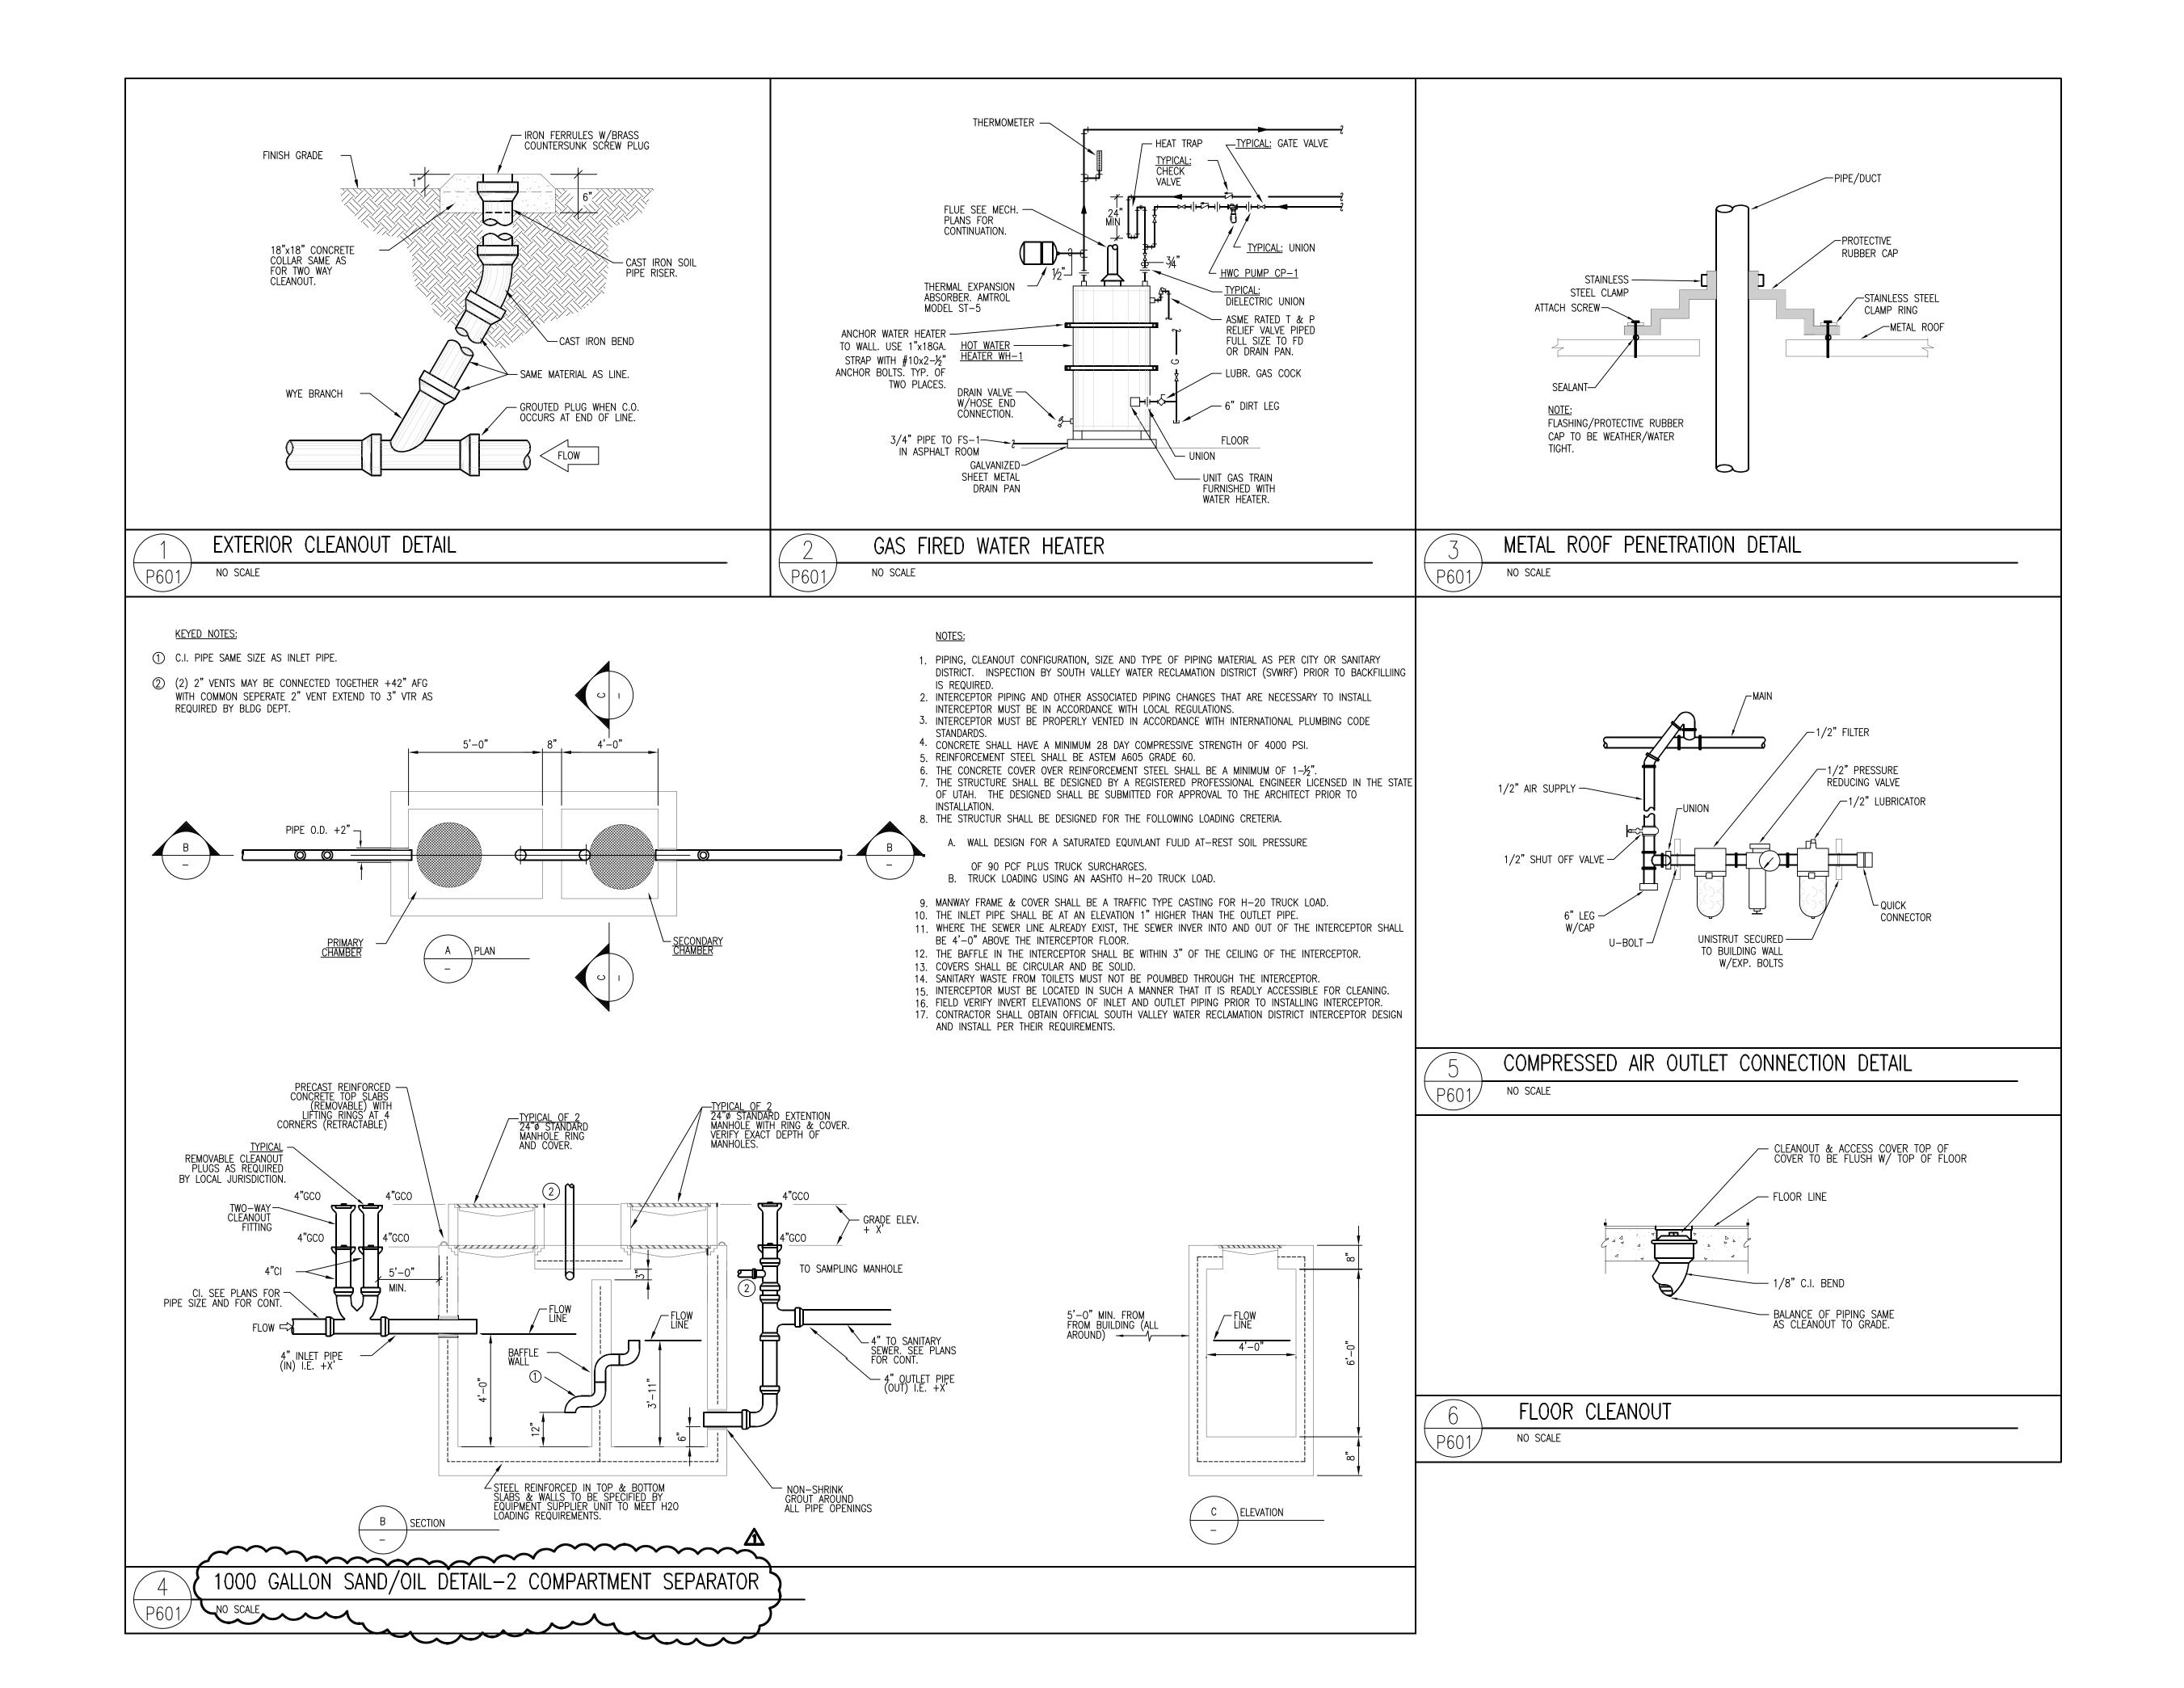

CLIENT

MEADOW
MAINTENANCE FACILITY
STATION #4534
400 N. MAIN
MEADOW, UTAH 84644

DESIGNER



architecture • planning • design services

1135 South West Temple, Ste. A
Salt Lake City, UT 84101
P:(801) 961-7070
F:(801) 961-7373

CONSULTANTS



90 South 400 West, Suite 340 Salt Lake City UT, 84101 Phone: (801) 359-3158 Fax: (801) 521-4114

REGISTRATION



NOT VALID UNLESS SIGNED

ISSUE		
$\overline{\Lambda}$	09/21/05	ADDENDUM 1
	09/02/05	BID DOCUMENTS
	08/12/05	FINAL REVIEW SET
	07/18/05	PRELIMINARY REVIEW SET

MARK DATE DESCRIPTION

PROJECT NO: 050008.01

DRAWN BY: M.M.

CHECKED BY: A.D.S.

SCALE:

SEPTEMBER 2, 2005

KEY PLAN

DATE:

SHEET TITLE

PVE Project No: 04080.02

PLUMBING DETAIL SHEET

P601

### ELECTRICAL SPECIFICATIONS

SECTION 16000 - GENERAL PROVISIONS

WORK CONSISTS OF FURNISHING LABOR, MATERIALS, EQUIPMENT AND SERVICES REQUIRED FOR THE COMPLETE INSTALLATION OF ELECTRICAL WORK SHOWN IN THE CONTRACT DOCUMENTS AND SPECIFIED IN

INCLUDE ALL PARTS AND LABOR, WHICH ARE INCIDENTAL AND NECESSARY FOR A COMPLETE AND OPERABLE INSTALLATION EVEN THOUGH NOT SPECIFICALLY MENTIONED IN THE CONTRACT DOCUMENTS. SUCH ITEMS INCLUDE NUTS, BOLTS, ANCHORS, BRACKETS, SLEEVES,

OBTAIN ALL TEMPORARY AND PERMANENT PERMITS AND LICENSES REQUIRED IN CONNECTION WITH THIS DIVISIONS WORK, PAY ALL FEES AND EXPENSES REQUIRED FOR SUCH PERMITS AND LICENSES.

REQUEST INSPECTIONS AS REQUIRED BY REGULATING AGENCIES AND/OR REGULATIONS. PAY ALL CHARGES FOR INSPECTIONS BY REGULATING AGENCIES OF INSTALLATIONS OF PLANS AND SPECIFICATIONS.

INCLUDE STATE AND LOCAL SALES TAXES IN THE BID. KEEP ACCURATE RECORDS OF THESE TAXES AND FURNISH SUCH RECORDS TO THE OWNER UPON REQUEST. MEET OR EXCEED ALL CURRENT APPLICABLE CODES, ORDINANCES AND REGULATIONS FOR ALL INSTALLATIONS. PROMPTLY NOTIFY THE ENGINEER, IN URITING, IF THE CONTRACT DOCUMENTS APPEAR TO CONFLICT WITH GOVERNING CODES AND REGULATIONS. CONTRACTOR ASSUMES ALL RESPONSIBILITY AND COSTS FOR CORRECTING

NON-COMPLYING WORK INSTALLED WITHOUT NOTIFYING THE ENGINEER. HIGHER QUALITY OF WORKMANSHIP AND MATERIALS INDICATED IN THE

CONTRACT DOCUMENTS TAKES PRECEDENCE OVER THAT ALLOWED IN REFERENCED CODES AND STANDARDS. THE TERMS DEFINED BELOW APPLY TO ALL WORK INCLUDED IN

a. THE WORK - AS DEFINED IN THE 1997 AIA DOCUMENT A201:
"THE TERM "WORK" MEANS THE CONSTRUCTION AND SERVICES
REGUIRED BY THE CONTRACT DOCUMENTS WHETHER COMPLETED
OR PARTIALLY COMPLETED, AND INCLUDES ALL OTHER LABOR, MATERIALS, EQUIPMENT AND SERVICES PROVIDED OR TO BE PROVIDED BY THE CONTRACTOR TO FULFILL THE CONTRACTORS OBLIGATIONS. THE WORK MAY CONSTITUTE THE WHOLE OR A PART OF THE PROJECT".

b. FURNISH - TO OBTAIN IN NEW CONDITION READY FOR INSTALLATION INTO THE WORK

c. INSTALL - TO STORE, SET IN PLACE, CONNECT AND PLACE INTO OPERATION INTO THE WORK.

d. PROVIDE - TO FURNISH AND INSTALL CONNECT - TO BRING SERVICE TO THE EQUIPMENT AND MAKE FINAL ATTACHMENT INCLUDING NECESSARY SWITCHES, OUTLETS, BOXES, TERMINATIONS, ETC.

f. CONDUIT - INCLUDES IN ADDITION TO CONDUIT, ALL FITTINGS, PULL BOXES, HANGERS AND OTHER SUPPORTS AND ACCESSORIES RELATED TO SUCH CONDUIT.

h. CONCEALED - HIDDEN FROM SIGHT IN CHASES, FURRED SPACES, SHAFTS, HUNG CEILINGS, EMBEDDED IN CONSTRUCTION, IN CRAWL SPACES OR BURIED.

g.EXPOSED - NOT INSTALLED UNDERGROUND NOR CONCEALED AS DEFINED ABOVE.

THE DRAWINGS AND SPECIFICATIONS CONSTITUTE THE CONTRACT DOCUMENTS. ANY ITEM NOTED IN THE SPECIFICATION OR SHOWN ON THE DRAWINGS IS INCLUDED IN THE CONTRACT DOCUMENTS.

ALL ELECTRICAL DETAILS AND DRAWINGS ARE DIAGRAMMATIC, UNLESS SPECIFICALLY NOTED. FIELD VERIFY ALL DIMENSIONS AND NOTIFY THE ENGINEER OF ANY CONFLICTS OR DISCREPANCIES, IN WRITING, PRIOR TO

INITIATE, MAINTAIN AND SUPERVISE ALL SAFETY PRECAUTIONS REQUIRED WITH THIS WORK IN ACCORDANCE WITH THE REGULATIONS OF THE OCCUPATIONAL SAFETY AND HEALTH ADMINISTRATION (OSHA) AND

DO NOT REMOVE OR DISTURB ANY ASBESTOS CONTAINING MATERIALS FROM THE PROJECT. IMMEDIATELY STOP WORK AND NOTIFY THE TENANT IF ASBESTOS CONTAINING MATERIALS ARE SUSPECTED.

BEFORE SUBMITTING A PROPOSAL ON THE WORK CONTEMPLATED EXAMINE THE SITE OF THE PROPOSED WORK AND BECOME THOROUGHLY FAMILIAR WITH EXISTING CONDITIONS AND LIMITATIONS. NO EXTRA FAMILIAR WITH EXISTING CONDITIONS AND LIMITATIONS. NO EXTRA COMPENSATION WILL BE ALLOWED BECAUSE OF MISUNDERSTANDING AS TO THE AMOUNT OF WORK INVOLVED NOR BIDDERS LACK OF KNOWLEDGE OF EXISTING CONDITIONS WHICH COULD HAVE BEEN DISCOVERED OR REASONABLY ANTICIPATED PRIOR TO BIDDING.

CONDUITS, PIPES, DUCTS, LIGHTS, DEVICES, SPEAKERS, ETC., SHOWN ON THE DRAWINGS AS EXISTING HAVE BEEN BASED ON THE EXISTING PLANS AND MAY NOT BE INSTALLED AS ORIGINALLY SHOWN. IT IS THE CONTRACTORS RESPONSIBILITY TO VISIT THE SITE AND MAKE EXACT DETERMINATION OF THE EXISTANCE, LOCATION AND CONDITION OF SUCH FACILITIES PRIOR TO SUBMITTING A BID

CONSULT THE DRAWINGS AND SPECIFICATIONS OF MECHANICAL AND OTHER TRADES FOR CORRELATING INFORTATION AND LAT OUT MORE OF THAT IT WILL COORDINATE WITH OTHER TRADES, VERIFY DIMENSIONS AND CONDITIONS (I.E., FINISHED CEILING HEIGHTS, FOOTING AND FOUNDATION ELEVATIONS, BEAM DEPTHS, ETC.). WITH THE ARCHITECTURAL AND STRUCTURAL DRAWINGS, NOTIFY THE ARCHITECT/ENGINEER OF ANY CONFLICTS THAT CANNOT BE RESOLVED IN THE FIELD, BY AFFECTED TRADES. REPLACEMENT OF WORK DUE TO LACK OF COORDINATION AND FAILURE TO VERIFY EXISTING CONDITIONS WILL BE COMPLETED AT NO COST TO THE OWNER.

INSTALL ALL CONDUIT, CABLE TRAY, BUSDUCT, EQUIPMENT, ETC. ALLOUING PROPER CODE AND MAINTENANCE CLEARANCES AND TO AVOID BLOCKING PASSAGEWAYS AND ACCESS PANELS. WHERE WORK MUST BE REPLACED DUE TO FAILURE OF THE CONTRACTOR TO VERIFY THE CONDITIONS EXISTING ON THE JOB, SUCH REPLACEMENT MUST BE ACCOMPLISHED AT NO COST TO THE OWNER. THIS APPLIES TO SHOP FABRICATED WORK AS WELL AS TO WORK

FABRICATED INPLACE. THROUGHOUT THE COURSE OF THE WORK, MINOR CHANGES AND ADJUSTMENTS TO THE INSTALLATION MAY BE REQUESTED BY THE ENGINEER. THE CONTRACTOR SHALL MAKE ADJUSTMENTS WITHOUT ADDITIONAL COST TO THE OWNER, WHERE SUCH ADJUSTMENTS ARE NECESSARY TO THE PROPER INSTALLATION AND OPERATION WITHIN THE INTENT OF THE CONTRACT DOCUMENTS. THIS DOES NOT INCLUDE WORK ALREADY COMPLETED.

OBTAIN EXACT LOCATION OF CONNECTION TO EQUIPMENT, FURNISHED BY OTHERS, FROM THE PERSON FURNISHING THE EQUIPMENT. DRAWINGS AND SPECIFICATIONS ARE COMPLEMENTARY AND WHAT IS CALLED FOR IN EITHER ONE IS AS BINDING AS IF CALLED FOR IN BOTH.

INCLUDE THE BETTER QUALITY, GREATER QUANTITY OR HIGHER COST FOR AN ITEM OR ARRANGEMENT WHERE A DISAGREEMENT EXISTS IN THE DRAWINGS AND SPECIFICATIONS. GUARANTEE AND MAINTAIN THE STABILITY OF WORK AND MATERIALS AND KEEP SAME IN PERFECT REPAIR AND CONDITION FOR THE PERIOD OF ONE (1) YEAR AFTER THE FINAL COMPLETION OF THE WORK AS EVIDENCED BY ISSUANCE OF THE FINAL CERTIFICATE BY THE OWNER.

DEFECTS OF ANY KIND DUE TO FAULTY WORK OR MATERIALS APPEARING DURING THE ABOVE MENTIONED PERIOD MUST BE IMMEDIATELY MADE GOOD BY THE CONTRACTOR AT HIS OWN EXPENSE TO THE ENTIRE SATISFACTION OF THE OWNER. INCLUDE DAMAGE TO

THE FINISH OR THE BUILDING RESULTING FROM THE ORIGINAL DEFECT OR REPAIRS. REPLACE ALL RECEPTACLES, SWITCHES, COVERPLATES, ETC. DAMAGED BY ANY CONTRACTOR DURING THE COURSE OF CONSTRUCTION. MATERIALS FURNISHED FOR THE TEMPORARY LIGHT AND POWER SYSTEM REMAIN CONTRACTORS PROPERTY. REMOVE WHEN THERE IS NO LONGER

ANY NEED FOR TEMPORARY LIGHT AND POWER. COORDINATE/SCHEDULE ALL WORK WITH THE OWNER TO MINIMIZE ANY DISRUPTIONS. CONFINE ALL INTERRUPTIONS TO THE SMALLEST POSSIBLE AREA. PROVIDE TEMPORARY CONNECTIONS IF REQUIRED TO PROVIDE

INSPECT ALL AREAS AFFECTED BY THE INTERRUPTIONS AND RETURN ALL AUTOMATICALLY CONTROLLED EQUIPMENT, ELECTRICALLY OPERATED EQUIPMENT TO THE SAME OPERATING CONDITION PRIOR TO THE

DO NOT DISTURB NORMAL USE OF THE FACILITY, EXCEPT WITHIN THE IMMEDIATE CONSTRUCTION AREA. KEEP WALKS, DRIVEWAYS, ENTRANCES, ETC. FREE AND CLEAR OF EQUIPMENT, MATERIAL AND DEBRIS. STORE ALL EQUIPMENT AND MATERIAL IN A PLACE AND MANNER THAT MINIMIZES CONGESTION AND IS APPROVED BY THE OWNER. PROVIDE NEW MATERIAL AND EQUIPMENT, UNLESS NOTED OTHERWISE. PROTECT EQUIPMENT AND MATERIAL FROM DAMAGE, DIRT AND THE WEATHER.

PROVIDE THE HIGHEST QUALITY WORKMANSHIP AND PERFORM ALL WORK ONLY BY SKILLED MECHANICS. INSTALL MATERIAL AND EQUIPMENT IN ACCORDANCE WITH MANUFACTURERS RECOMMENDATIONS, INSTRUCTIONS

THE OWNER RESERVES THE RIGHT TO REJECT MATERIAL OR WORKMANSHIP NOT IN ACCORDANCE WITH THE SPECIFICATIONS, BEFORE OR AFTER INSTALLATION.

PERFORM ALL CUITING AND PATCHING NECESSARY TO WORK, UNLESS SPECIFICALLY DELEGATED TO THE GENERAL CONTRACTOR, OBTAIN SPECIAL PERMISSION FROM THE LANDLORD BEFORE CUITING STRUCTURAL MEMBERS OR FINISHED MATERIAL. PERFORM ALL STRUCTURAL MEMBERS OR FINISHED MATERIAL. PERFORM ALL
PATCHING IN SUCH A MANNER AS TO LEAVE NO VISIBLE TRACE AND
RETURN THE AREA AFFECTED TO THE CONDITION OF UNDISTURBED
WORK. PERFORM ALL PATCHING BY WORKERS EXPERIENCED, SKILLED,
AND LICENSED FOR THE PARTICULAR TYPE OF WORK INVOLVED. INFERIOR WORK WILL NOT BE ACCEPTED.

PATCH ALL HOLES LEFT AS A RESULT OF DEMOLITION OF ELECTRICAL EQUIPMENT AND DEVICES. PREVENT THE SPREAD OF DUST, DEBRIS, AND OTHER MATERIAL INTO ADJACENT AREAS. REFINISH ALL ELECTRICAL EQUIPMENT DAMAGED DURING SHIPPING AND/OR INSTALLATION TO ITS ORIGINAL CONDITION. REMOVE ALL RUSTS PRIME, AND PAINT PER MANUFACTURERS RECOMMENDATIONS FOR FINISH EQUAL TO ORIGINAL.

AFTER TESTS HAVE BEEN MADE AND ACCEPTED, CLEAN LIGHT FIXTURES, PANELS AND OTHER EQUIPMENT INSTALLED BY THE CONTRACTOR, LEAVING THE ENTIRE WORK AREA IN A CLEAN AND

OPERATE EQUIPMENT AND SYSTEMS IN ALL THIER OPERATING MODES, TO VERIFY PROPER OPERATION, PRIOR TO FINAL INSPECTION AND OWNER INSTRUCTIONS. NOTIFY THE ENGINEER, IN WRITING, THAT ALL SYSTEMS HAVE BEEN TESTED AND ARE FUNCTIONING AND OPERATING

CONTRACTOR IS RESPONSIBLE FOR ANY DAMAGE TO ELECTRICAL EQUIPMENT OR MATERIALS UNTIL FINAL ACCEPTANCE OF THE ENTIRE PROVIDE TEMPORARY WIRING AND CONNECTIONS TO MAINTAIN EXISTING SYSTEMS, INCLUDING TELEPHONE AND DATA SYSTEMS, IN SERVICE DURING CONSTRUCTION. WHEN WORK MUST BE PERFORMED ON ENERGIZED EQUIPMENT OR CIRCUITS, USE PERSONNEL EXPERIENCED IN

EXISTING ELECTRICAL SERVICE: MAINTAIN EXISTING SYSTEM IN SERVICE DISABLE SYSTEM ONLY TO MAKE SWITCHOVERS AND CONNECTIONS. NOTIFY AND OBTAIN PERMISSION FROM OWNER/ENGINEER AT LEAST 24 HOURS BEFORE PARTIALLY OR DISABLING SYSTEM, MINIMIZE OUTAGE DURATION, MAKE TEMPORARY CONNECTIONS TO MAINTAIN SERVICE IN AREAS ADJACENT TO WORK AREA.

EXISTING TELEPHONE, DATA, CCTV & SECURITY SYSTEM MAINTAIN EXISTING SYSTEMS IN SERVICE. DEMOLISH AND EXTEND EXISTING ELECTRICAL WORK UNDER AND THIS SECTION, AND AS INDICATED ON THE DRAWINGS. REMOVE, RELOCATE, AND EXTEND EXISTING INSTALLATIONS TO ACCOMODATE NEW CONSTRUCTION.

PROVIDE SUPPORTS FOR ALL EXISTING ELECTRICAL EQUIPMENT THAT WAS SUPPORTED PREVIOUSLY BY DEMOLISHED WALLS, FLOORS, CEILING OR OTHER STRUCTURES. PROVIDE NEW SUPPORTS FROM STRUCTURAL MEMBERS NOT SLATED FOR DEMOLITION, PRIOR TO ANY DEMOLITION. CUNER RESERVES THE RIGHT OF FIRST REPUSAL TO OBTAIN MATERIAL SHOWN TO BE REMOVED UNDER THIS CONTRACT. ITEMS NOT RETAINED BY THE OWNER BECOME THE PROPERTY OF THE CONTRACTOR AND MUST BE REMOVED FROM THE PREMISES.

EXTEND EXISTING INSTALLATIONS USING MATERIALS AND METHODS COMPATIBLE WITH EXISTING ELECTRICAL INSTALLATIONS, OR AS SPECIFIED. RELOCATE AND REPOUTE CONDUIT AND WIRING AS REQUIRED FOR CONDUIT CONCEALED IN WALLS OR STRUCTURE DEING ALTERED AS DARK OF THE DESCRIPTION OF THE DESCRIPTI PART OF THE REMODELING. MAINTAIN CONTINUITY TO ALL DEVICES IN

REPOUTE EXISTING RACEWAY AND WIRING, WHICH IS EXPOSED DUE TO REMOVAL OF EXISTING CONSTRUCTION. CONCEAL NEW RACEWAY AND WIRING AND MAINTAIN OPERATION.

SECTION 16050 - BASIC MATERIALS AND METHODS ENCASE ALL CONDUCTORS IN A CONTINUOUS RACEULAY SYSTEM. PROVIDE PULL AND JUNCTION BOXES AS REQUIRED BY THE NEC. SIZE ALL RACEWAY PER THE NEC WITH OVERSIZED CONDUITS AS INDICATED.

PROVIDE JUNCTION BOXES OR GUTTER AT BRANCH PANEL AND

PROVIDE EXPANSION FITTINGS WHERE RACEWAY CROSSES BUILDING

AND DOWNSTREAM OF REMODELED WORK.

RUN ALL EXPOSED CONDUIT IN A NEAT, WORKMANLIKE MANNER PARALLEL TO THE BUILDING LINES, TIGHT TO THE WALL AND CEILING SURFACES, AND FIRMLY SUPPORT WITH CONDUIT CLAMPS OR HANGERS. PROVIDE TWO (2) HOLE MOUNTING STRAPS, MINIMUM THREE (3) FEET ON CENTER FOR ALL SURFACE CONDUIT MOUNTED ON WALLS LESS THAN SIX (6) FEET ABOVE FINISHED FLOOR. PLACE CONDUITS AT LEAST 8" AWAY FROM ALL HOT PIPING AND SURFACES INCLUDING

PROVIDE GALVANIZED CODE GUAGE STEEL JUNCTION AND PULL BOXES WITH SCREW ON COVERS OF TYPE, SHAPE AND SIZE REQUIRED TO SUIT EACH INSTALLATION. PROVIDE GASKETING IN DAMP AND DUSTY LOCATIONS. PROVIDE CAST BOXES IN WEATHERPROOF, VAPOR TIGHT

PROVIDE 4" BOXES THROUGHOUT. PROVIDE 3-1/2" DEEP BOXES WHERE INSTALLED IN MASONRY, 2-1/2" MINIMUM ELSEUHERE. YAPOR TIGHT GANG MUD OR TILE RING FOR SINGLE DEVICES.

COORDINATE THE LOCATION OF ALL OUTLETS WITH MECHANICAL

PROVIDE WIRE AND CABLE WITH INSULATION VOLTAGE RATING EQUAL TO PROVIDE WIRE AND CABLE WITH INSULATION VOLTAGE RATING EQUAL TO OR GREATER THAN THE APPLIED SYSTEM VOLTAGE. PROVIDE SOLID OR STRANDED COPPER CONDUCTORS WITH TYPE THUN, THIN, OR XHIN INSULATION FOR NO. 12 AUG AND NO. 10 AUG CONDUCTORS. PROVIDE MINIMUM NO. 12 AUG CONDUCTOR SIZE, UNLESS NOTED OTHERWISE. USE THE MINIMUM CONDUCTOR SIZE WHEN NO SIZE IS INDICATED. ALL CONDUCTORS TO BE COLOR-CODED.

SECTION 16501 - BUILDING LIGHTING

DRAWINGS BEFORE INSTALLATION.

PROVIDE LIGHTING FIXTURES AS SCHEDULED CAU HOUSING LAMPS, LAMP HOLDERS, REFLECTORS, BALLASTS & WIRING. FLUORESCENT LAMP BALLAST FOR TS & T5 LAMPS SHALL BE ELECTRONIC CBM CERTIFIED W/ THD LESS THAN 20%

SUPPORT ALL RECESSED LIGHTING FIXTURES W/4 \* 12GA. WIRES INDEPENDENT FROM CEILING SUPPORT SYSTEM.

PANELBOARD SCHEDULE																
PANEL 'A'				•					. \ 18 VO			_	3		— PH	4 W
	-							120/20	<u></u> *0			-			-' ''	<del></del>
MOUNTING FLUSH													10	CATIO	N٠	MEZZ. 201
XX SURFACE								****								MEADOW MAINT.
RATING: 10,000	SERVIC	E RA	<b>NTE</b>	D				AMP	225	- MB			-	(OULC	''-	MILADOW MAINT.
			- 1.					ICH BR				10.0			I	
1777.4	I			WIRE			PHASE		_	PHASE		CIR.			WIRE	1
ITEM		POL	E	SIZE		A 1100	В	С	A 1000	В	С			_	SIZE	
LIGHTING	20	+	+	12	3	1100	1000		1000	600		4	20	1	12	RECEPTACLES
	╂┼	↤	┥	+	5		1000	1300	<del>                                     </del>	000	600	6	$\vdash\vdash$	╁┼	++	<del>                                     </del>
	╅	┥	┪	$\dashv$	7	1500	$\vdash$	,,,,,,	600	$\vdash$	1000	8	$\vdash$	┰	++	<del>                                     </del>
	+	$\vdash$	+	$\dashv$	9	1500	1100			400		10	$\vdash$	┰	+	<del>                                     </del>
<del> </del>	+	Н	7	$\neg$	11		1100	1100			1000	12		$\vdash$	$\top$	
DOORS	$\vdash$	П	7	$\neg$	13	1000			1000			14		$\sqcap$		
			T		15		1000			600		16				
					17			1000			600	18				
19 1000 400 20 1 1 1																
	₩	Н	4	_	21		1000			700		22		ш		BURNERS
<b></b>	┷	₩	4		23			1000	4=00		1500	24	25	1	10	VACUUM PUMP
001100000	11	1	4	Ļ		1000			1500	4500		26	25	1	10	VACUUM PUMP
COMPRESSOR	90	3	٦	6	27		2900	0000		1500	2400	28	25	1	10	FURNACE F-1
7-1/2 HP-VERIFY	-	<u> </u>	4		29	0000		2900	0.400		2400	30 32	40	2	10	COND. UNIT
LIFT	50	3	┥	8	31 33	2900	3600		2400	700		34	20	3	12	EF-2
LIF I	- 50	-	┪	<u> </u>	35		3600	3600		700	700	36	_	-	12	<u> </u>
_	+=	<del>                                     </del>	+	<del>-</del>		3600	$\vdash$	3000	700	$\vdash$	/00	38	_	<del>                                     </del>	+=	-
SPARE	20	1	-		39	3000			,,,,,			40	20	1		SPARE
SPARE	20	1	┪		41							42		1		SPARE
							10600		7600	4500	6800					
TOTAL 19700 15100 17700 LOAD TOTAL 52500																
FLA <u>146</u>																
																_
	/													ノ		
												_	_			

### INDEX OF ELECTRICAL DRAWINGS

ELECTRICAL SYMBOLS & NOTES LIGHTING PLAN E2.1 E3.1 POWER PLAN

		LIGHTING	FIXTURE SCHEDULE					
FIXTURE TYPE	MANUFACTURE	CATALOG NIMBER	LAMP8	atr	FIX WATTS	MTG	VOLT	
A	METALUX	8TDIM232-12ØY	8' 4-LAMP INDUSTRIAL FLUORESCENT FIXTURE	F32T8 6P35	4	110	PEND.	120
В	METALUX	2FC8-332A-12ØV EB81	RECESSED FLANGED 2'X4' 3-LAMP FLUORESCENT FIXTURE	F32T8 9P35	3	98	REC.	120
c	METALUX	₩8232A-12ØY EB81	SURFACE MOUNTED FLUORESCENT WRAP AROUND FIXTURE	F32T8 9P35	2	68	SURF.	120
EL	SURELITES	CC7NC6D-9M	EMERGENCY BATTERY PACK	C/W UNIT	2	32	SURF.	120
×I	SURELITES	LPX70DG-WH	LED EXIT SIGN	LED	-	32	UNIY.	120
OA	LUMARK	MHWL250-120V	OUTDOOR 250W METAL HALIDE WALLPACK	25@W MH	1	275	SURF.	120

# GENERAL NOTES

DO NOT SCALE DRAWINGS VERIFY DIMENSIONS IN FIELD PRIOR TO MAKING

FINAL CONNECTIONS TO EQUIPMENT SHALL BE MADE AS PER MANUFACTURERS URITTEN INSTRUCTIONS AND APPROVED WIRING DIAGRAMS AND DETAILS. IT SHALL BE THE CONTRACTORS RESPONSIBILITY TO PROVIDE ALL MATERIALS AND EQUIPMENT COMPATIBLE WITH EQUIPMENT ACTUALLY SUPPLIED.

CONSULT ARCHITECTS REFLECTED CEILING PLANS FOR EXACT LOCATIONS OF LIGHTING FIXTURES, SPEAKERS, SMOKE DETECTORS ETC.

ELECTRICAL CONTRACTOR SHALL MEET WITH THE CEILING AND MECHANICAL CONTRACTORS TO COORDINATE LOCATIONS, CLEARANCES, CEILING TYPES AND ROUGH-IN REQUIREMENTS OF ALL LIGHTING FIXTURES PRIOR TO DUCT, PIPING AND CEILING INSTALLATIONS.

ALL EMPTY RACEUAY SYSTEMS SHALL HAVE A 200LB RATED PULL CORD INSTALLED AND SHALL BE IDENTIFIED AT EACH JUNCTION, PULL AND TERMINATION POINT, USING PERMANANT MARKER IN THE BOX. ID SHALL INDICATE INTENDED USE OF CONDUIT, ORIGINATION AND TERMINATION POINTS OF EACH INDIVIDUAL CONDUIT.

ALL PENETRATIONS OF FIRE RATED FLOORS, CEILING AND WALLS SHALL BE SEALED WITH APPROVED AND RATED FIRE STOP MATERIAL TO MAINTAIN FIRE RATING OF

ELECTRICAL BOXES SHALL NOT BE LOCATED IN MASONRY OR CONCRETE COLUMNS, BOND BEAMS OR GROUTED CELLS OF MASONRY WALLS ADJACENT TO OPENINGS WITHOUT COORDINATION WITH THE MASONRY CONTRACTOR.

IT IS THE INTENT OF THESE DRAWINGS AND SPECIFICATIONS TO ESTABLISH A A STANDARD OF GUALITY. THE ENGINEER RESERVES THE RIGHT TO VERBALLY APPROVE METHODS AND MATERIALS NOT REFLECTED HEREIN.

CONTRACTOR SHALL REVIEW ARCHITECTURAL, STRUCTURAL, MECHANICAL, PLUMBING AND OTHER DRAWINGS PRIOR TO BID

10. WORK SHALL BE PERFORMED IN A PROFESSIONAL WORKMANLIKE MANNER TO THE

WORK, MATERIALS AND EQUIPMENT SHALL CONFORM TO THE LATEST EDITIONS OF LOCAL, STATE AND NATIONAL CODES, STANDARDS AND ORDINANCES. CONTRACTOR SHALL SECURE AND PAY FOR ALL NECESSARY BUILDING PERMITS

THE CONTRACTOR SHALL GUARANTEE THE INSTALLATION AGAINST DEFECTS IN MATERIALS AND WORDMANSHIP, WHICH MAY OCCUR UNDER NORMAL USAGE FOR A PERIOD OF ONE YEAR AFTER SUBSTANTIAL COMPLETION. DEFECTS SHALL BE

4. PROVIDE RECORD DRAWINGS IN ACCORDANCE WITH THE PROJECT SPECIFICATIONS.

5. VERIFY EXACT LOCATION OF EQUIPMENT TO BE FURNISHED BY OTHERS PRIOR 16. ELECTRICAL CONTRACTOR SHALL VERIFY ALL EQUIPMENT DIMENSIONS AND

LOCATIONS BEFORE BEGINNING ROUGH-INS. CONSULT CONTRACT DOCUMENT DRAWINGS AND SHOP DRAWINGS TO VERIFY ALL CODE AND MAINTENANCE

CONTRACTOR SHALL VERIFY ACTUAL ELECTRICAL LOADS OF EACH PIECE OF EQUIPMENT REQUIRING POWER. BRING ANY DESCREPANCIES TO THE ATTENTION OF THE PROJECT ENGINEER. SYSTEMS SHALL BE TESTED FOR PROPER OPERATION. IF TESTS RESULT IN

DEFECT OR IMPROPER OPERATION THE CONTRACTOR SHALL MAKE AN CORRECTIONS NECESSARY AT NO ADDITIONAL COSTS TO THE OWNER. WIRE SHALL BE COPPER 75° C RATED FOR GENERAL USE. FOR HID FIXTURES AND WIRNG WITHIN 3" OF FLUORESCENT BALLAST SHALL BE COPPER, MINIMUM 90° C RATED. CONDUCTOR SIZES INDICATED ARE FOR INSTALLATION IN A

MAXIMUM 30° C AMBIENT TEMPERATURE ENVIRONENT. CONDUCTOR AMPACITY SHALL BE DERATED FOR HIGHER AMBIENT INSTALLATIONS. 10. SPLICES IN EXTERIOR PULLBOXES AND MANHOLES SHALL BE MADE WATERPROOF

USING "SCOTCAST" SPLICE KIT OR APPROVED EQUAL. SEAL ENDS OF CONDUITS AND DUCTS ENTERING BOXES WITH "DUCTSEAL" OR EQUAL. SUBMIT SHOP DRAWINGS IN ACCORDANCE WITH SPECIFICATIONS BOUND IN A THREE RING BINDER, INDEXED IN A NEAT AND ORDERLY MANNER WITH TYPE AND MODEL NUMBERS INDICATED. SUBMITTALS SHALL INCLUDE BUT NOT LIMITED TO: LIGHTING FIXTURES, LAMPS, WIRING DEVICES, OCCUPANCY SENSORS, CONTACTORS, TIME CLOCKS, PHOTOCELLS, RELAYS, SWITCHBOARDS, PANELBOARDS, MOTOR CONTROL CENTERS, SAFETY SUITCHES, MOTOR STARTERS, OVERCURRENT PROTECTION DEVICES, TRANSFORMERS, CONDUCTORS OVER 600 VOLTS AND ALL SPECIAL SYSTEMS SUCH AS FIRE ALARM, LIGHTING CONTROLS, SECURITY SYSTEMS,

VERIFY EXACT LOCATIONS OF ALL NEW AND EXISTING UNDERGROUND SITE UTILITIES, PIPING AND RACEWAY SYSTEMS PRIOR TO TRENCHING. PROVIDE NECESSARY TRENCHING, BACKFILL EXCAVATION, SUPPORTS, SERVICE FEEDERS, (CONDUIT AND/OR WIRE), PULL BOXES, TRANSFORMER PADS, SAW CUTTING AND PATCHING, CONCRETE PAVING ETC, REQUIRED. BACKFILL TRENCHES TO 90% COMPACTION AND PATCHING TO MATCH EXISTING. CONTRACTOR SHALL OBTAIN AND VERIFY EXACT UTILITY COMPANY DRAWINGS AND REQUIREMENTS FOR ALL SITE UTILITIES. ELECTRICAL CONTRACTOR SHALL ALSO COORDINATE ELECTRICAL RELATED UTILITIES WITH THE CIVIL AND MECHANICAL ENGINEERS AND CONTRACTORS.


PULLBOXES, CABINETS, ETC. MOUNTED ON THE EXTERIOR OF THE BUILDING AT GRADE LEVEL, SHALL BE WEATHERPROOF TYPE WITH HINGED GASKETED LOCKABLE COVERS SECURED WITH TAMPERPROOF SCREWS.


OTTIDOL	DESCRIPTION	HEIGHT	140120
	ONE CIRCUIT, TWO WIRE HOME RUN TO PANEL		
#	2 CIRCUIT, 3 WIRE, COMMON NEUTRAL HOME RUN		
#	3 CIRCUIT, 4 WIRE, COMMON NEUTRAL HOME RUN		
	CONDUIT RUN CONCEALED IN WALL OR CEILING		
	CONDUIT RUN CONCEALED IN FLOOR OR GROUND		
<u> </u>	CONDUIT UP		
-	CONDUIT DOWN		
$\overline{}$	CONDUIT STUB LOCATION	CAP	
0	CEILING LIGHT FIXTURE	CEILING	
Ю	WALL LIGHT FIXTURE	AS NOTED	
	RECESSED DOWNLIGHT FIXTURE	CEILING	
0	FLUORESCENT LIGHT FIXTURE	AS NOTED	
	FLUORESCENT EGRESS LIGHT FIXTURE		UNSWITCHED
			UNOWITCHED
8	CEILING MOUNTED EXIT LIGHT	CEILING	
l⊗ •	WALL MOUNTED EXIT LIGHT	AS NOTED	
\$	SINGLE POLE SWITCH	+4'-0"	
\$*	SINGLE POLE SWITCH	+4'-0"	
\$3	THREE-WAY SWITCH	+4'-0"	
\$4	FOUR-WAY SWITCH	+4'-0"	
\$K	KEY OPERATED SWITCH	+4'-@"	
\$°	SWITCH WITH PILOT LIGHT	+4'-0"	
149	VARIABLE INTENSITY SWITCH	+4'-0"	
7	TIMER SWITCH	+4'-0"	
<del>-</del>	DUPLEX RECEPTACLE	+16"	
⊕		710	
	DUPLEX RECEPTACLE		
⊕ ₩	ELECTRIC WATER COOLER RECEPTACLE		
	WEATHERPROOF RECEPTACLE	+24"	
⊕ <sub>IG</sub>	ISOLATED GROUND RECEPTACLE	+16"	
<b>₹</b>	GROUND FAULT INTERRUPTER DUPLEX RECEPTACLE	+16"	
-	DUPLEX RECEPTACLE EMERGEMCY POWER (RED)	+16"	
#	FOURPLEX RECEPTACLE	+16"	
₩≡	FOURPLEX RECEPTACLE EMERGEMCY POWER (RED)	+16"	
•	FLOOR OUTLET WITH 200A DEVICE	FLOOR	
	SPECIAL PURPOSE OUTLET	+16" OR	
	DATA OUTLET	AS NOTED	
	TELEPHONE OUTLET	+16"	
	TELEPHONE/DATA OUTLET	+16"	
0	TELEPHONE OUTLET	FLOOR	
<u> </u>	JUNCTION BOX ("F" IN FLOOR)	AS NOTED	
<i>\O</i> /	MOTOR OUTLET	to suit Equip.	
	NON-FUSED DISCONNECT SWITCH	+5'-0"	
F	FUSED DISCONNECT SWITCH	45'-Ø"	
\$⁺	MANUAL STARTER THERMAL OVERLOAD SWITCH WITH PILOT L	GH14'-0"	
	PANEL BOARD	TOP AT +6'-0"	
	MAIN DISTRIBUTION PANEL		
	TELEPHONE TERMINAL BOARD		
<u>——</u>	CLOCK OUTLET	+7'-6"	8.
	FIRE ALARY MANUAL STATION	+4'-0"	2.
H	FIRE ALARM SIGNAL SPEAKER/STROBE	46'-8"	6.
			·
(Os	SMOKE DETECTOR	CEILING	Address to 1 mars 1 min
<b>⊙</b> p	DUCT SMOKE DETECTOR		MTD. IN DUCT
<u> </u>	HEAT DETECTOR	CEILING	
•	SOUND SYSTEM SPEAKER	48'-0" OR AS NOTED	
<b>1</b>	MONITOR SPEAKER OUTLET	AS NOTED	
$\overline{\mathbb{N}}$	TELEVISION OUTLET	+4'-0"	2.
842	ARCHITECTURAL ROOM NUMBER		
A	LIGHT FIXTURE (LETTER DESIGNATES TYPE)		
(EG)	EQUIPMENT NUMBER		
\34/	encount		

ELECTRICAL SYMBOL SCHEDULE

STANDARD MOUNTING HEIGHT UNLESS OTHERWISE NOTED ON PLANS

SYMBOL DESCRIPTION

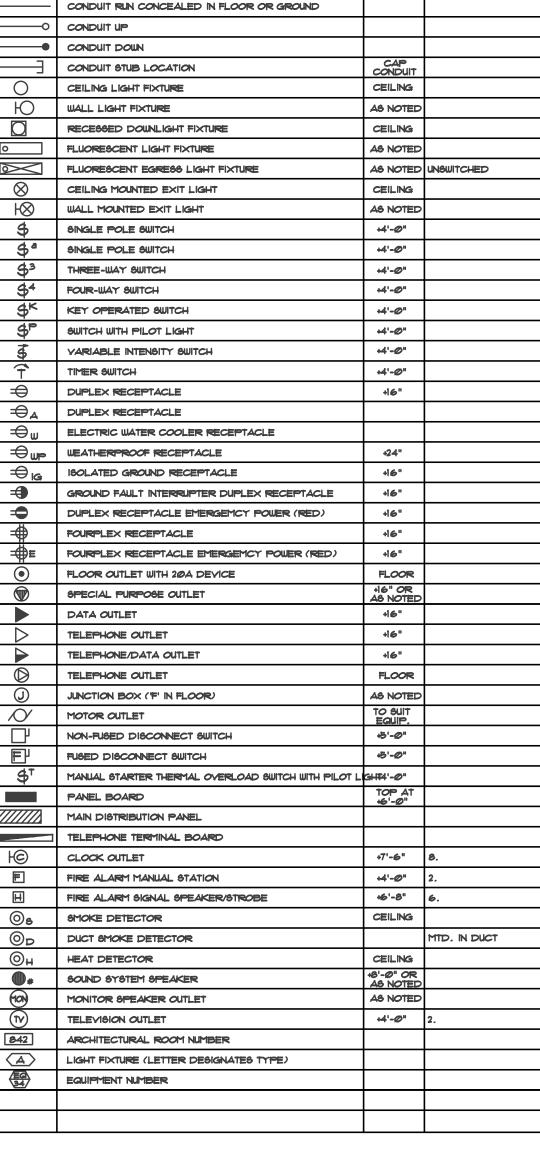

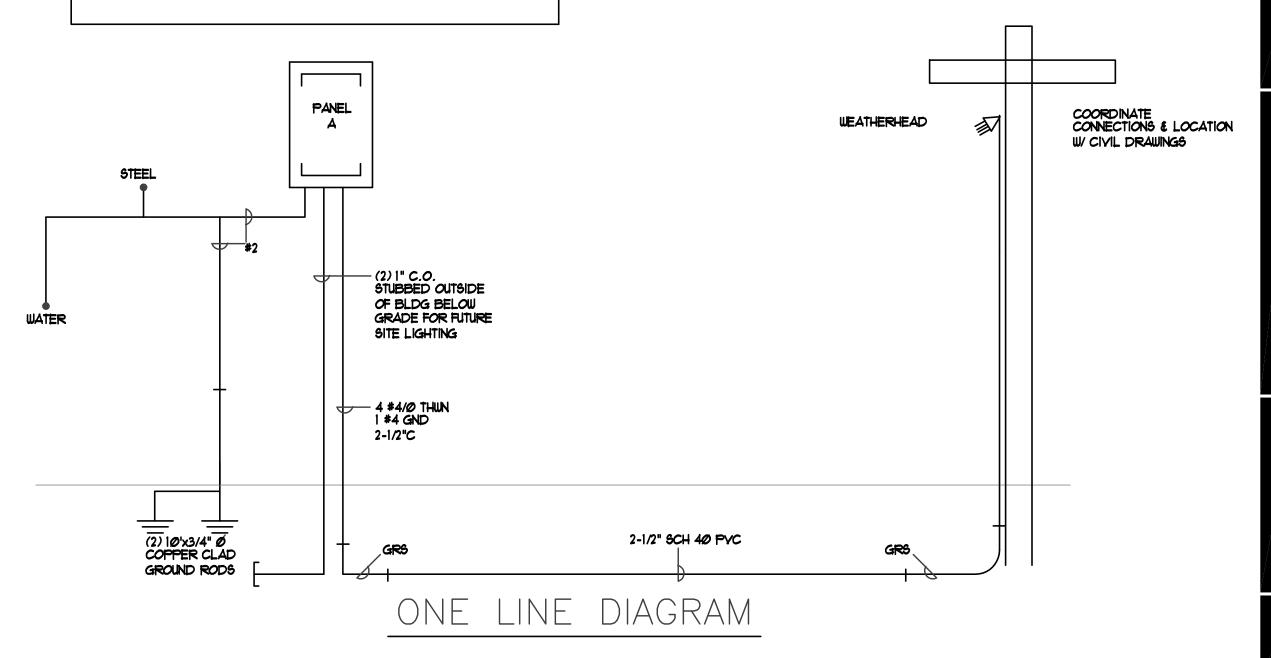

CLIENT

NOTES

MEADOW MAINTENANCE FACILITY STATION #4534 400 N. MAIN MEADOW, UTAH 84644

DESIGNER




architecture · planning · design services 1135 South West Temple, Ste. A Salt Lake City, UT 84101 P:(801) 961-7070 F:(801) 961-7373

CONSULTANTS



90 South 400 West, Suite 340 Salt Lake City UT, 84101 Phone: (801) 359-3158 Fax: (801) 521-4114 PVE Project No: 04080.02

REGISTRATION

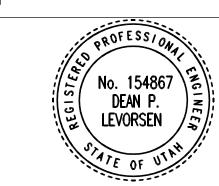

ISSUE

| 09/26/05| ADDENDUM 1 |09/02/05| BID DOCUMENTS

– |08/12/05| FINAL REVIEW SET |07/18/05| REVIEW SET


MARK DATE DESCRIPTION

ARCHIPLEX PROJECT NO: 04080.03 K.D.M. DRAWN BY: R.K.R. CHECKED BY:

DATE: SEPTEMBER 2, 2005 KEY PLAN

SHEET TITLE

ELECTRICAL **SCHEDS & NOTES** 

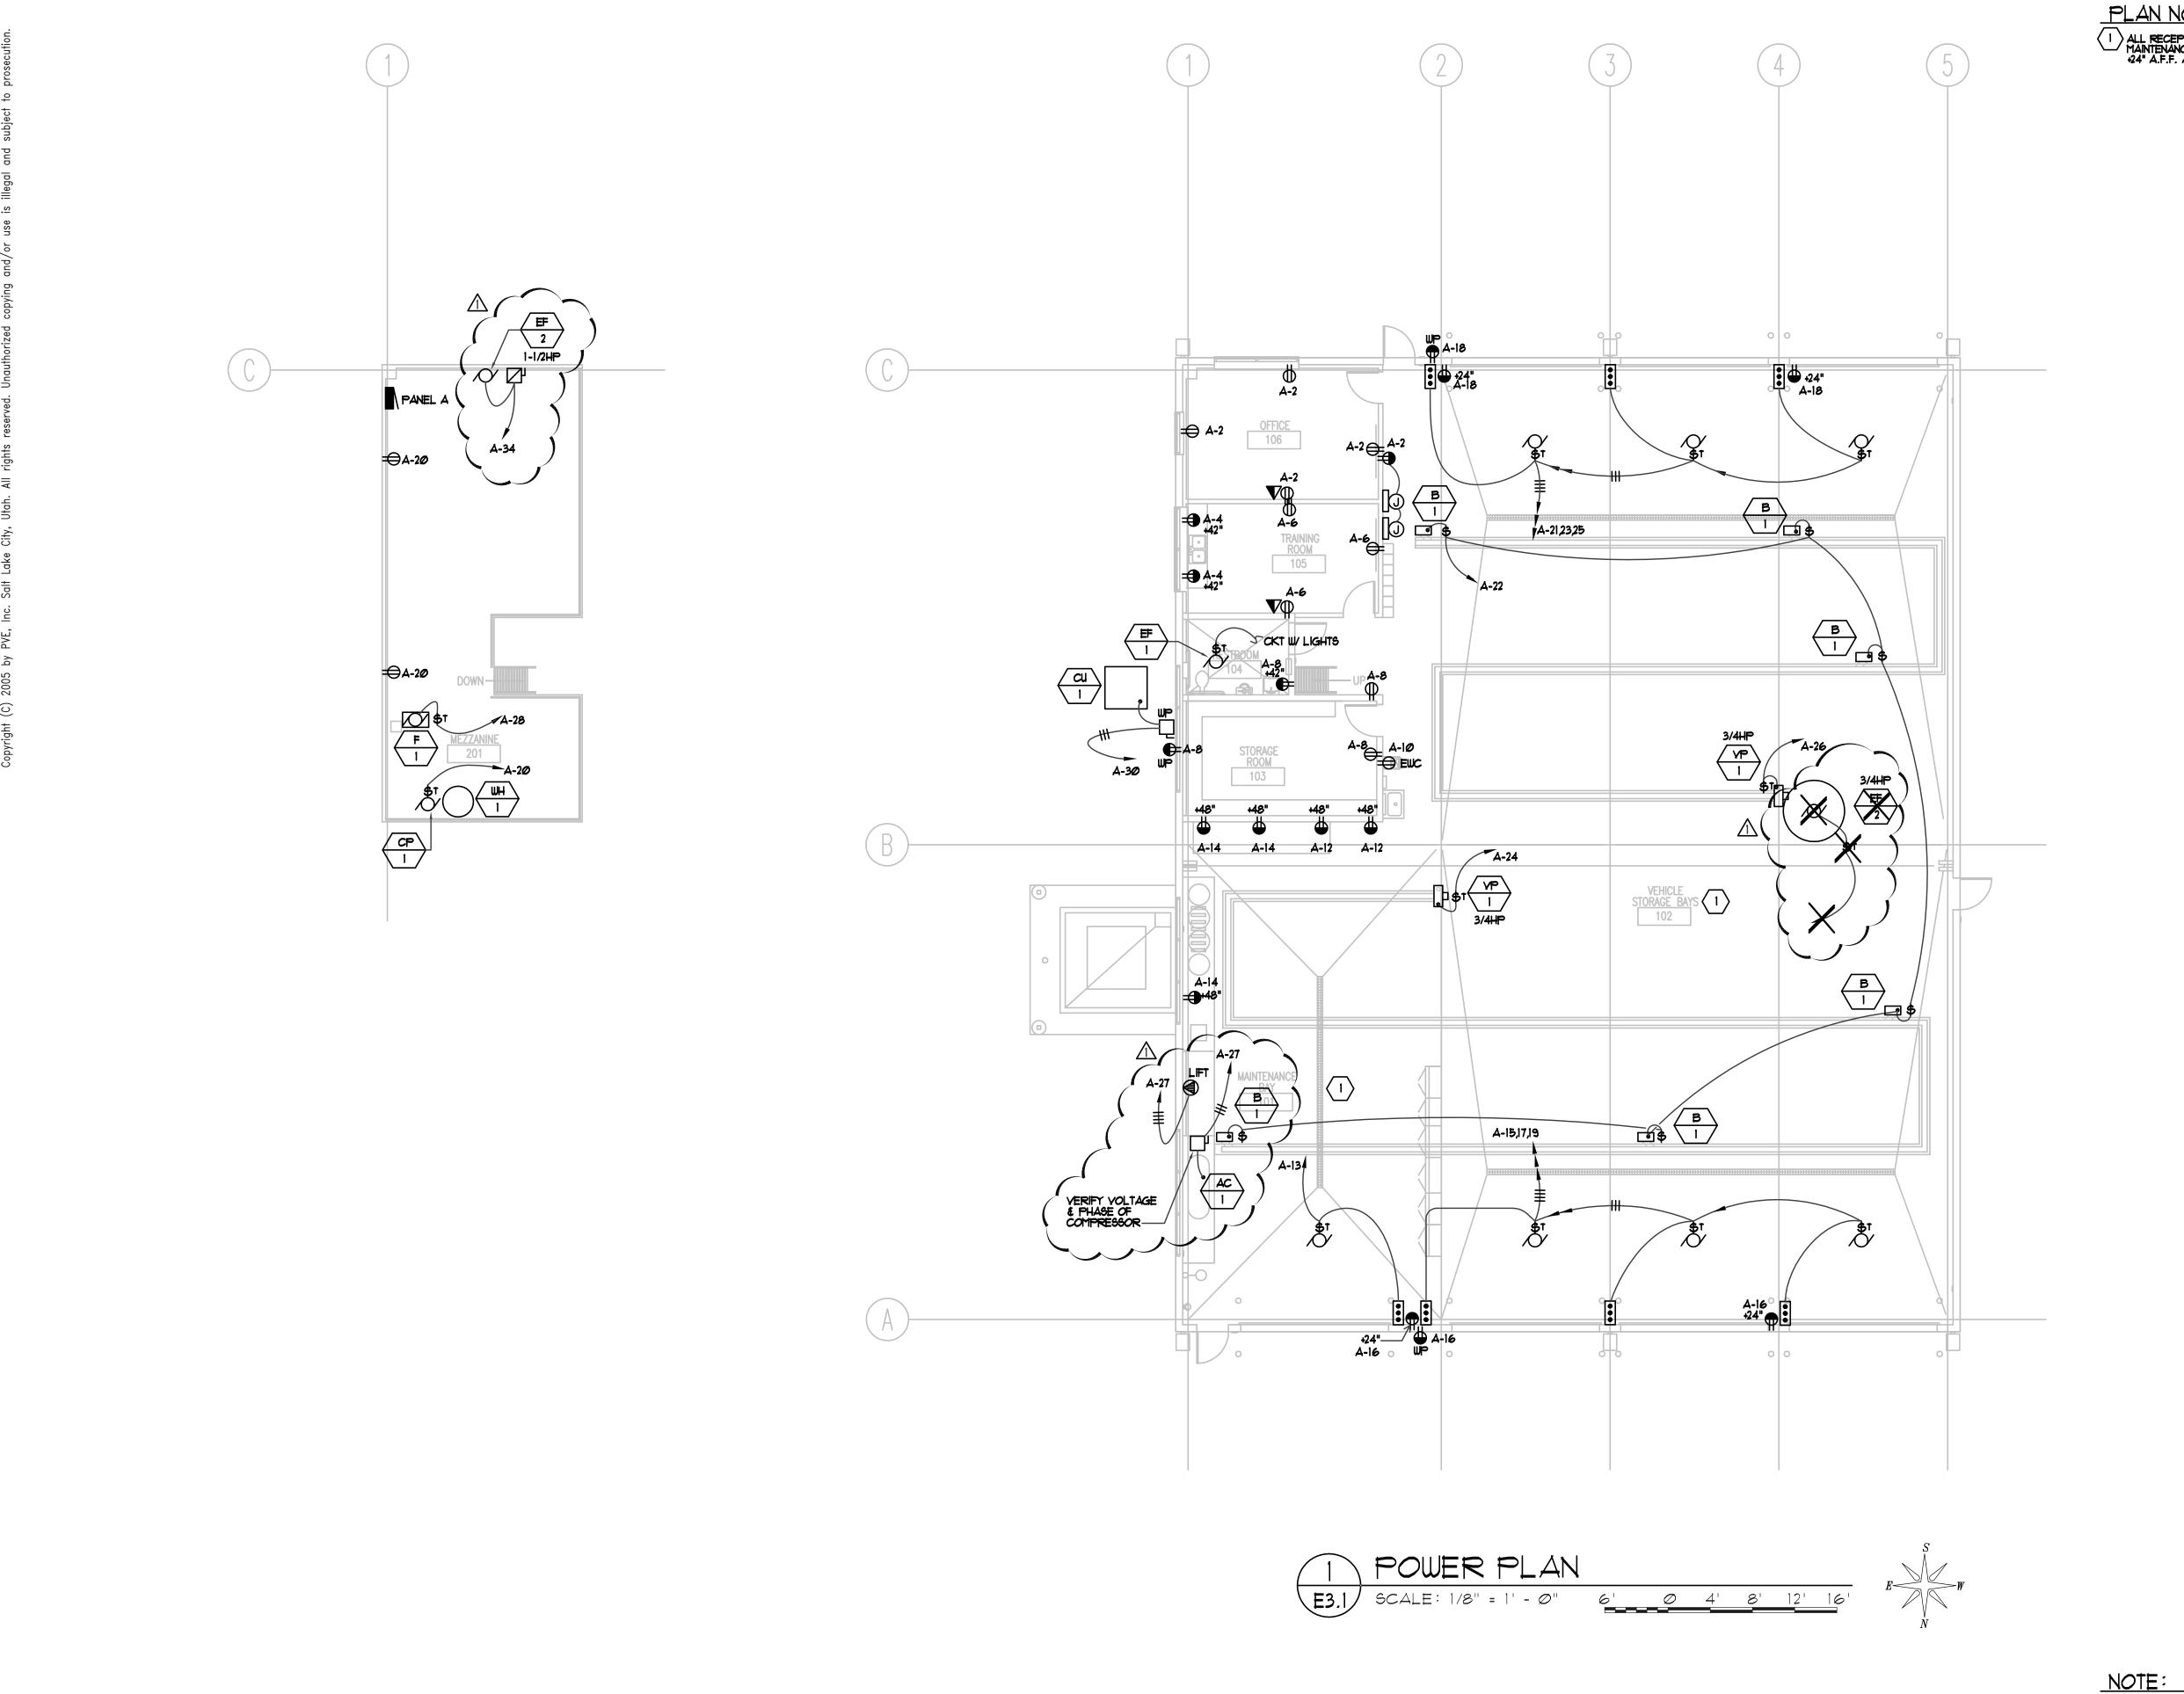

PLAN NOTES ALL RECEPTACLES IN VEHICLE STORAGE BAYS AND MAINTENANCE BAY SHALL BE MOUNTED A MINIMUM OF 424" A.F.F. AND BE A GFC! TYPE RECEPTACLE.

MEADOW MAINTENANCE FACILITY STATION #4534 400 N. MAIN MEADOW, UTAH 84644

DESIGNER

CLIENT




architecture · planning · design services 1135 South West Temple, Ste. A
Salt Lake City, UT 84101
P:(801) 961-7070
F:(801) 961-7373

CONSULTANTS



90 South 400 West, Suite 340 Salt Lake City UT, 84101 Phone: (801) 359-3158 Fax: (801) 521-4114 PVE Project No: 04080.02

REGISTRATION

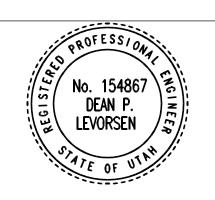

- 09/26/05 ADDENDUM 1 - 09/02/05 BID DOCUMENTS - 08/12/05 FINAL REVIEW SET 07/18/05 REVIEW SET

MARK DATE DESCRIPTION ARCHIPLEX PROJECT NO:

04080.03 K.D.M. DRAWN BY: R.K.R. CHECKED BY:

SEPTEMBER 2, 2005 DATE:

KEY PLAN

SHEET TITLE

ALL ELECTRICAL INSTALLATIONS & WIRING SHALL BE PROVIDED IN ACCORDANCE WITH ARTICLE 511 NEC COMMERCIAL GARAGES, REPAIR & STORAGE.

POWER PLAN

E3.1